GENERAL

- 1. STANDARDS OF CONSTRUCTION: ALL CONSTRUCTION SHALL CONFORM TO THE LATEST CITY OF ANSONIA STANDARDS, RULES AND REGULATIONS REGARDLESS OF WHAT MAY BE INDICATED ON THE PLANS.
- 2. IMPORTED FILL: IF THE SITE REQUIRES IMPORTED FILL IN THE PROPOSED MUNICIPAL RIGHT OF WAY OR MUNICIPAL OWNED PROPERTY, ALL FILL MUST FOR COMPOSITION AND CHEMICALS IN ACCORDANCE WITH DPW DIRECTIONS AND AT THE FULL EXPENSE OF THE OWNER. RESULTS MUST BE RECEIVED PRIOR TO DEPOSITING MATERIAL ON MUNICIPAL APPROVE THE FILL, KEEP RECORDS, AND REVIEW THE CHAIN OF CUSTODY DOCUMENTATION OF EACH TRUCK BROUGHT TO THE SITE. NUMBER OF SAMPLES MUST BE TAKEN AND TESTED BY A CONNECTICUT STATE CERTIFIED LABORATORY. IN ADDITION, POLLUTION INSURANCE MUST BE PROVIDED PRIOR TO CONSTRUCTION, IN THE AMOUNT TO HE DETERMINED BY THE COMMISSIONER OF PUBLIC WORKS
- 3. STORMWATER MANAGEMENT: PLACE APPROVED NOTES REGARDING CONSTRUCTION MAINTENANCE PROGRAM AND RESPONSIBIL HOMEOWNER'S ASSOCIATION OR OTHER APPROVED ENTITY ON THE PLANS INCLUDING CORRECTIVE MEASURES WHEN DEFICIENCIES ARE IDENTIFIED. AN ESCROW ACCOUNT MUST HE ESTABLISHED FOR THE MAINTENANCE OF ACT OUTLET CONTROL STRUCTURES STORMWATER QUALITY/QUANTITY ATTENUATION FACILITIES. THE COMMISSIONER OF PUBLIC WORKS HAS THE RIGHT TO UTILIZE THIS ESCROW ACCOUNT TO PERFORM MAINTENANCE WORK SHOULD THE HOMEOWNER'S ASSOCIATION OR OTHER APPROVED ENTITY FAIL TO HE RESPONSIVE. FURTHER, THE DEPARTMENT OF PUBLIC WORKS SHALL RECEIVE 20% OF ALL COSTS AS AN ADMINISTRATIVE FEE. THE DESIGN AND CONSTRUCTION OF OUTLET CONTROL STRUCTURES, QUALITY/QUANTITY STORMWATER ATTENUATION FACILITIES, AND ASSOCIATED STRUCTURES SHALL BE UNDER THE SUPERVISION OF AND CERTIFICATION BY THE STORMWATER MANAGEMENT LICENSED DESIGN ENGINEER OF RECORD. SUPPLEMENTAL LANGUAGE PROVIDED BY DPW MAY BE PROVIDED FOR INCLUSION ON THE PLANS.
- 4. EROSION, DUST & SEDIMENT CONTROL: THE DEVELOPER RESPONSIBLE FOR PROVIDING PROPER EROSION, CONTROL. ALL EROSION AND SEDIMENT CONTROL MUST BE SIZED AND DESIGNED IN ACCORDANCE WITH THE STANDARDS AND GUIDELINES PRESENTED IN THE LATEST CTSDEC REGULATIONS. THE DEVELOPER SHALL SUBMIT TO THE COMMISSIONER FOR APPROVAL, A PLAN WITH DETAILS DELINEATING THE METHODS HE INTENDS TO USE FOR EROSION, SEDIMENTATION AND DUST CONTROL DURING THE CONSTRUCTION OF THIS PROJECT. SILT PROTECTION AND ACT WATER RETENTION BASINS WILL BE THE FIRST ITEMS OF CONSTRUCTION. THE EROSION, SEDIMENTATION AND DUST CONTROLS MUST BE MAINTAINED THROUGHOUT CONSTRUCTION OR A STOP WORK ORDER WILL BE ISSUED BY DPW.
- 5. ELEVATION DATUM: ELEVATIONS SHOWN ON THE PLANS SHALL REFER TO MUNICIPAL DATUM.
- 6. SURVEY AND HORIZONTAL & VERTICAL CONTROL: A CERTIFIED SURVEY OF THE PROPERTY SHALL BE SUBMITTED TO DPW WITH THE ENTIRE PARCEL INCLUDING THE RIGHTS-OF-WAY AND EASEMENTS COORDINATED IN THE CONNECTICUT STATE PLANE COORDINATE SYSTEM EAST ZONE. PRIOR TO BEGINNING CONSTRUCTION, HORIZONTAL AND VERTICAL CONTROL LINES MUST BE ESTABLISHED THROUGHOUT THE SITE FOR USE DURING CONSTRUCTION BY THE DEVELOPER AND DPW STAFF FOR CHECKING LINE AND GRADE_ IT SHALL BE THE DEVELOPERS RESPONSIBILITY TO MAINTAIN THESE CONTROL LINES THROUGHOUT THE LIFE OF THE JOB.
- 7. INDUSTRIAL CODE RULE '753: THE DEVELOPER SHALL NOTIFY ALL UTILITY COMPANIES 72 HOURS PRIOR TO THE START OF HIS OPERATIONS AND SHALL COMPLY WITH ALL THE LATEST INDUSTRIAL CODE RULE 753 REGULATIONS.
- 8. VERIFICATION AND PROTECTION OF EXISTING UTILITIES: THE DEVELOPER SHALL VERIFY THE SIZE, LOCATION, DEPTH AND INVERTS OF ALL EXISTING UTILITIES PRIOR TO COMMENCING HIS OPERATIONS. THE DEVELOPER SHALL PRESERVE AND PROTECT EXISTING PRIVATE AND MUNICIPAL UNDERGROUND AND OVERHEAD UTILITIES AND STRUCTURES, WHETHER OR NOT THEY ARE SHOWN ON THE APPROVED PLANS OR LOCATED UNDER INDUSTRIAL CODE RULE 753. THE COST OF REPAIRING DAMAGED UTILITIES OR STRUCTURES SHALL BE BORNE BY THE DEVELOPER. IF TEMPORARY UTILITIES ARE REQUIRED IT IS THE RESPONSIBILITY OF THE DEVELOPER TO PROVIDE AND MAINTAIN SAID UTILITIES
- 9. NOTIFICATIONS: THE DEVELOPER SHALL MAKE PROPER ADVANCE NOTIFICATIONS (MINIMUM 48 HR. NOTICE OR AS REQUIRED), FOR ALL WORK REQUIRING INSPECTION AND APPROVAL OF ALL GOVERNING AGENCIES
- 10.PIPE LAYOUT: THE DEVELOPER SHALL PERFORM ALL PROPOSED PIPE LAYOUT REQUIRED BY MEANS OF A LASER FOR EXACT VERTICAL AND HORIZONTAL ALIGNMENT. THE USE OF BATTER BOARDS, AS SPECIFIED IN THE MUNICIPAL STANDARD CONSTRUCTION SPECIFICATIONS ARTICLE 33.132 - "LAYOUT", SHALL NOT BE ALLOWED. THE DEVELOPER'S EQUIPMENT MUST HAVE BEEN CALIBRATED WITHIN THE PREVIOUS SIX (6) MONTHS PRIOR TO CONSTRUCTION. WRITTEN PROOF OF CALIBRATION MUST BE PROVIDED IF REQUIRED BY THE COMMISSIONER OF PUBLIC WORKS.
- 11.INSPECTION & BACKFILL: NO BACKFILL SHALL BE PLACED OVER NEW CONSTRUCTION PRIOR TO INSPECTION AND APPROVAL BY DPW. THE DEVELOPER MUST HAVE A SUFFICIENT STOCKPILE OF CLEAN FILL IF EXCAVATED MATERIAL IS UNSUITABLE FOR BACKFILL (IE., ROCK, ORGANIC MATERIAL). THE USE OF CONTROLLED BACKFILL MATERIAL MAY BE REQUIRED IN TRENCHES IF DETERMINED BY THE COMMISSIONER OF PUBLIC WORKS.

- 12. TEMPORARY CERTIFICATES OF OCCUPANCY (TCO): DURING CONSTRUCTION ISSUED BY THE BUILDING DEPARTMENT WITHOUT APPROVAL BY DPW FOR ACT DWELLING UNIT CONSTRUCTED, WITHOUT THE INSTALLATION OF MUNICIPAL CURBING AND PAVEMENT BASE AND BINDER UTILITIES (SEWER, STORM AND WATER MAINS, ETC.). SANITARY SEWERS AND WATER MAINS MUST HAVE FINAL ACCEPTANCE BY THE WESTCHESTER COUNTY HEALTH DEPARTMENT PRIOR TO THE ISSUANCE OF A TOO
- 13. INSPECTION OF COMPLETED WORKS: DURING CONSTRUCTION. STAFF OF DPW WILL PERFORM A FIELD INSPECTION OF ALL COMPLETED WORK PRIOR TO ACCEPTANCE. ACT ITEMS OF WORK THAT DO NOT COMPLY WITH DPW'S CURRENT CONSTRUCTION STANDARDS AND/OR THE APPROVED CONSTRUCTION DRAWINGS WILL BE NOTED AND SUBMITTED IN WRITING TO THE DEVELOPER FOR CORRECTION.

EROSION CONTROL:

- 1. INSTALL ALL EROSION CONTROL DEVICES AS INDICATED ON DRAWINGS AND IN ACCORDANCE WITH THE CONNECTICUT STATE STANDARDS \$ SPECIFICATIONS FOR EROSION & SEDIMENT CONTROL, LATEST REVISION.
- 2. CONTRACTOR SHALL MAINTAIN ALL EROSION CONTROL DEVICES DURING COURSE OF CONSTRUCTION
- 3. EROSION CONTROL DEVICES SHALL NOT BE REMOVED UNTIL FULL VEGETATION GROWTH HAS OCCURRED AND AS APPROVED BY THE MUNICIPAL INSPECTOR.
- 4. SEEDING AND MULCHING SHALL BE AS FOLLOWS: TEMPORARY SEEDING & MULCHING
 - 90LBS./1,000 SQ.FT. GROUND LIMESTONE, FERTILIZER: 4LBS./1,000 SQ.FT., 10-20-10 OR EQUIVALENT WORKED INTO SOIL A MINIMUM OF 4 INCHES
 - : ANNUAL RYEGRASS 40 LBS./ACRE OR OTHER APPROVED SEED, PLANT BETWEEN MARCH 1 AND MAY 15 OR BETWEEN AUGUST 15 AND OCTOBER 1
 - 4.3. MULCH: SALT HAY OR SMALL GRAIN STRAW AT A RATE OF TO TO 90 LBS./1,000 SQ.FT. TO BE APPLIED ACCORDING TO STANDARD PRACTICES. MULCH SHALL BE SECURED BY APPROVED METHODS


- 1. THE SITE SHALL BE GRADED AS INDICATED ON THE DRAWINGS. PROPOSED CONTOURS SHALL BE GRADED TO BLEND EVENLY WITH THE EXISTING CONTOURS
- 2. ALL DISTURBED AREAS WHICH WILL BE LEFT EXPOSED FOR MORE THAN THIRTY (30) DAYS AND NOT SUBJECTED TO CONSTRUCTION TRAFFIC SHALL IMMEDIATELY RECEIVE TEMPORARY SEEDING. IF THE SEASON PROHIBITS TEMPORARY SEEDING, THE DISTURBED AREA WILL BE MULCHED WITH SALT HAY, OR APPROVED EQUAL, AND BOUND AS PER THE CONNECTICUT STATE STANDARDS & SPECIFICATIONS FOR EROSION AND SEDIMENT CONTROL
- 3. FILL MATERIAL SHALL BE CLEAN FILL AND SHALL BE INSTALLED IN 12 INCH LIFTS AND COMPACTED TO 95% OPTIMUM DENSITY
- 4. ALL STREET OPENINGS FOR UTILITY INSTALLATION (I.E. SANITARY SEWER LATERAL & WATER SERVICE) SHALL BE BACKFILLED WITH CONTROL DENSITY FILL (K-CRETE) TO THE BOTTOM OF THE EXISTING ASPHALT PAVEMENT.
- 5. ALL STREET OPENINGS SHALL BE CUT BACK A MINIMUM OF 12 INCHES TO PROPERLY BLEND IN THE NEW ASPHALT PATCH AREA
- 6. ALL WATER SERVICES SHALL BE 1-1/2" DIAMETER TYPE "K" COPPER TUBING.
- 7. ALL SANITARY SEWER LATERALS SHALL BE 4" DIAMETER EXTRA HEAVY CAST IRON (XHCI) PIPE.
- 8. A MINIMUM OF 10'-0" HORIZONTAL AND 18" VERTICAL SEPARATIONS BETWEEN NEW WATER SERVICE AND NEW SEWER LATERALS SHALL BE MAINTAINED


PROPOSED SITE DEVELOPMENT

Prepared For

WAKELEE ENTERPRISES, LLC Situated At

557 WAKELEEE AVE CT ROUTE 334 CITY OF ANSONIA NEW HAVEN CO., CONNECTICUT

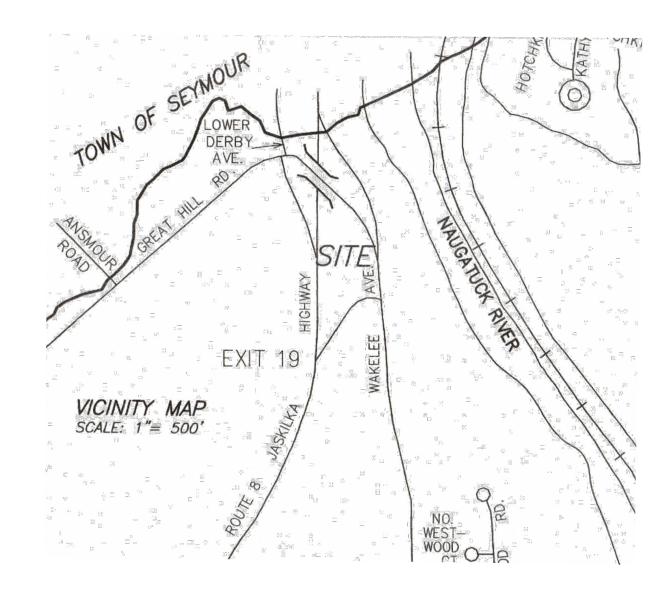

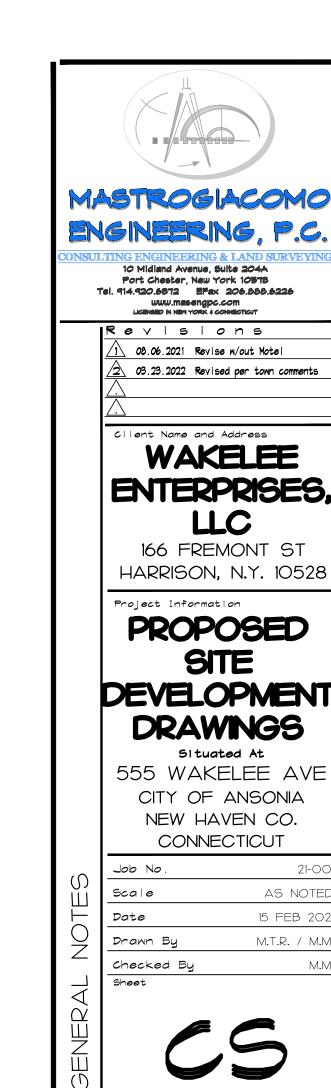



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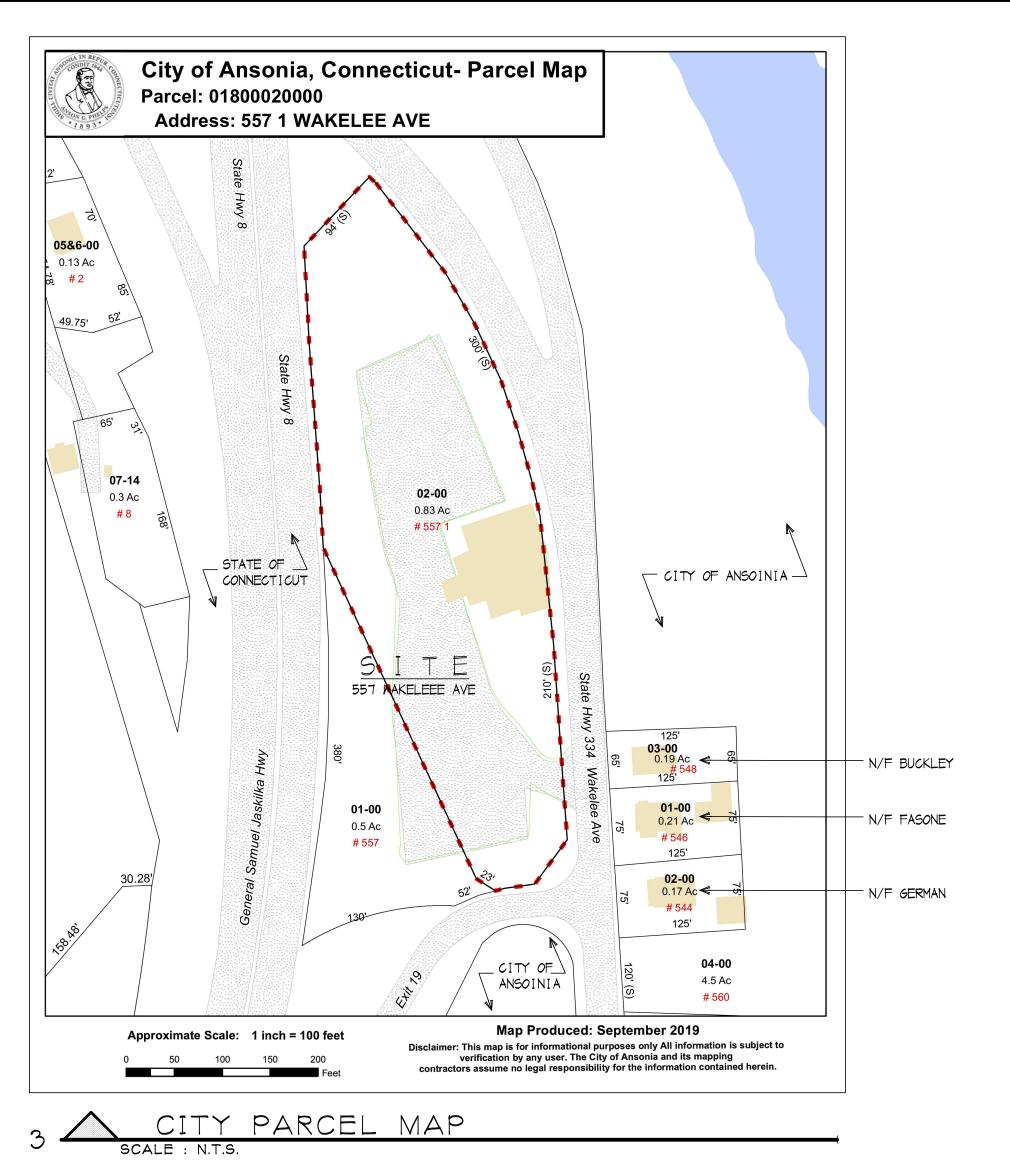
ZONING MAP

SCALE : N.T.S.

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B) <u>C Districts:</u> Minimum La
District abuts a residential of

	<u>District Code</u> C Districts
MINIMUM REQUIREMENTS:	
1. Yards	Not required if not provided.
2. Yards, <u>if provided:</u> Side Yard Rear Yard	5 feet (Exception - See Note A) 12 feet
3. Landscaped buffer against Residential Districts	(See Note B)
Off-street parking and loading spaces	(See Note C)
5. Front landscape depth	6 feet (See Note D)
6. Lot area per dwelling unit	4,000 sq. ft. (See Note E)
7. Outdoor Space	(See Note F)
MAXIMUM REQUIREMENTS:	
8. Height in Stories	3 Stories
9. Height in Feet	42 feet

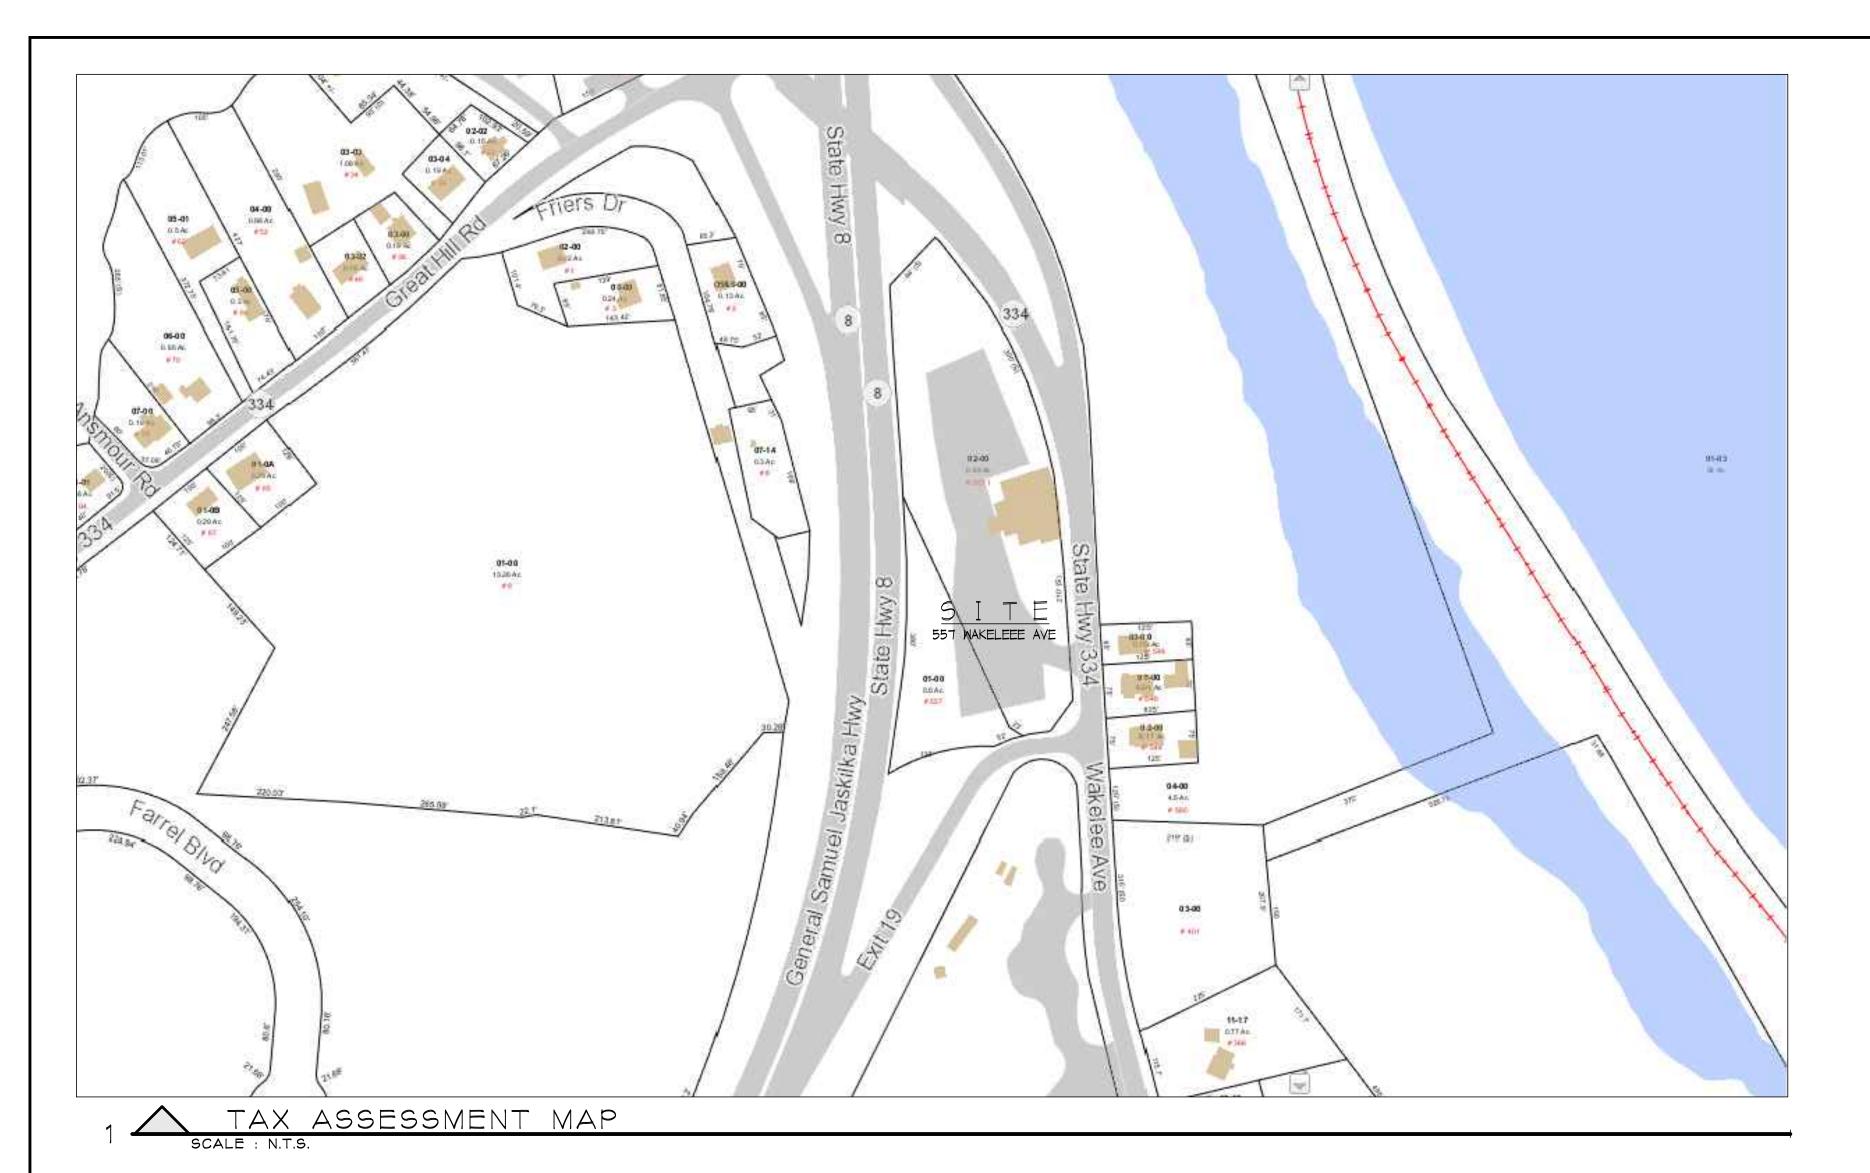
- <u>C Central Commercial Districts:</u> Side Yard. (As in table) Except that the minimum width of a side yard for other than a fire resistant building shall be five (5) feet for each story height of such a building.
- C Districts: Minimum Landscaped Buffer against residential districts. When the C District abuts a residential district without an intervening street, a permanent landscaped buffer twenty-five (25) feet in depth shall be required to shield the commercial activities from the adjoining residential area. Where the depth of a C District is less than one hundred fifty (150) feet, however, the depth of this landscaped buffer may be reduced to not less than ten (10) feet, provided that the Zoning Commission is satisfied that the

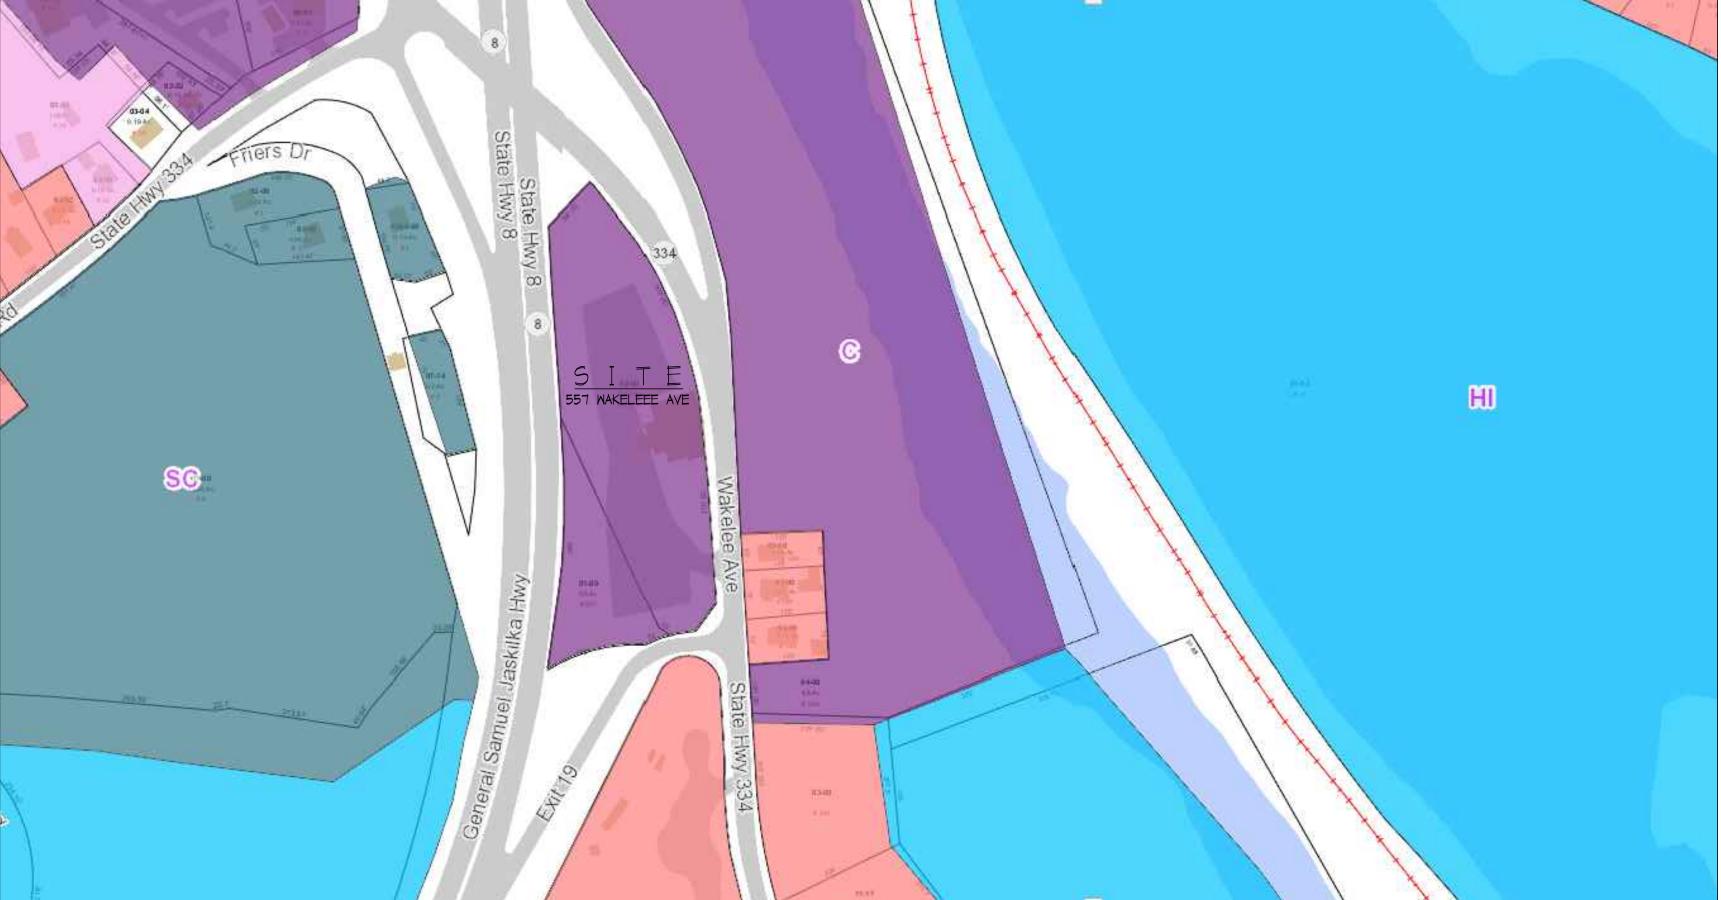nature of the planting or fences is adequate to provide effective screen.

C Districts: Minimum off-street parking and loading spaces. As required in Section 410.

The required number of parking spaces is based on type of use served by the parking. The exception to the parking requirement in C Central Commercial Districts is specified in Section

- C) <u>C Districts:</u> Minimum Front Landscape Depth. Front landscape areas shall extend across the full width of the lot along the interior side of the front lot line, except where buildings, driveway entrances and exits are located, to the depth required in tis Schedule.
- <u>C Districts:</u> Dwelling units shall be permitted in "C" Commercial District only on the second or third floors above street level commercial space.
- <u>C Districts:</u> For each dwelling unit there shall be three hundred (300) square feet of useable landscaped space, or an amount determined by the Planning and Zoning Commission, adjacent to the building or a balcony for each dwelling unit, which balcony shall have a minimum useable depth of six (6) feet and a minimum area of seventy (70) square feet. The access to each dwelling unit shall be provided by means of one or more doorways directly to the outside or to a hallway and/or stairway leading directly to the outside, without need to pass through any store, shop, office or other non-dwelling floor area. Any hallway giving principal access to a dwelling shall not also provide principal public access to any non-dwelling floor areas. The Commission may approve interior lounge areas, or courtyards, including interior recreation spaces, roof top terraces, or landscaped courtyards in lieu of the adjacent landscaped space where such design maximizes the space on the same lot or within the structure on the lot to afford residents an area of recreation and common area. Such areas shall be three hundred square feet (300) for each dwelling unit. Maintenance of such areas shall be the responsibility of the building owner or in such cases where the units are owned, a suitable legal common interest community declaration approved by the Ansonia Corporate counsel.

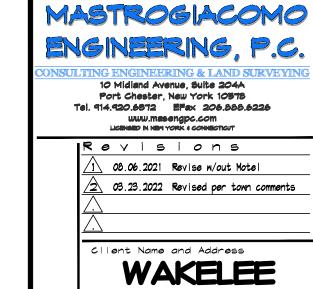

ILC
166 FREMONT ST
HARRISON, N.Y. 10528

ENTERPRISES,


PROPOSED SITE DEVELOPMENT DRAWINGS


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555 WAKELEE AVE
CITY OF ANSONIA
NEW HAVEN CO.
CONNECTICUT


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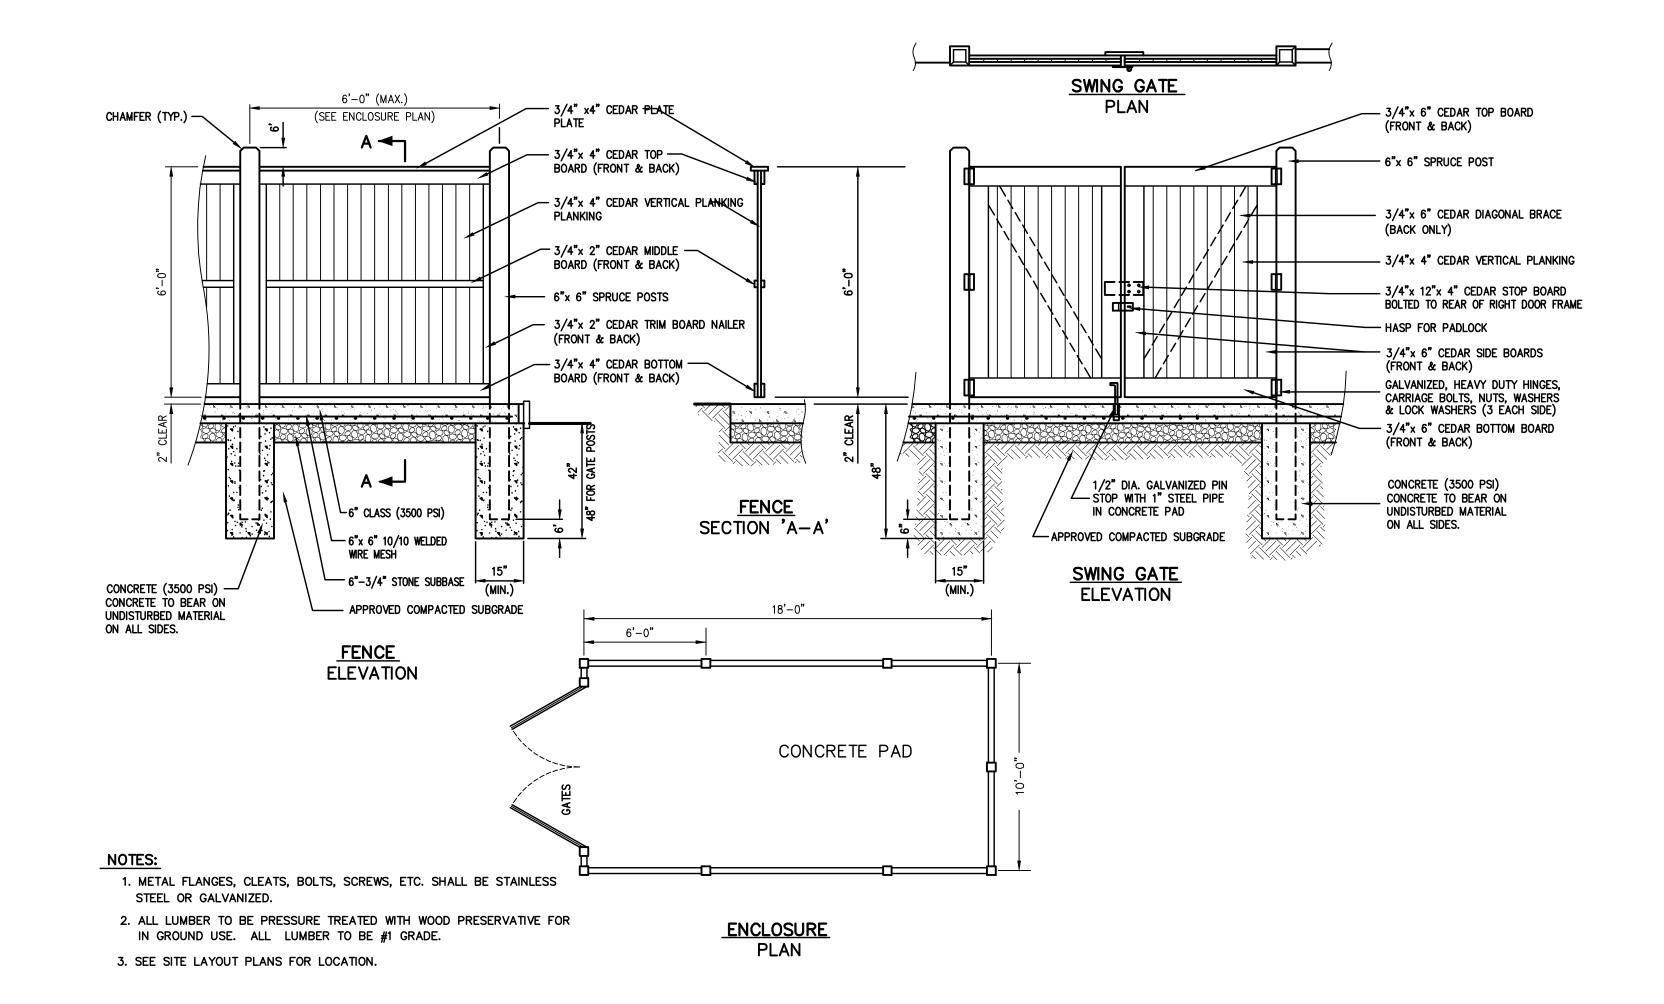




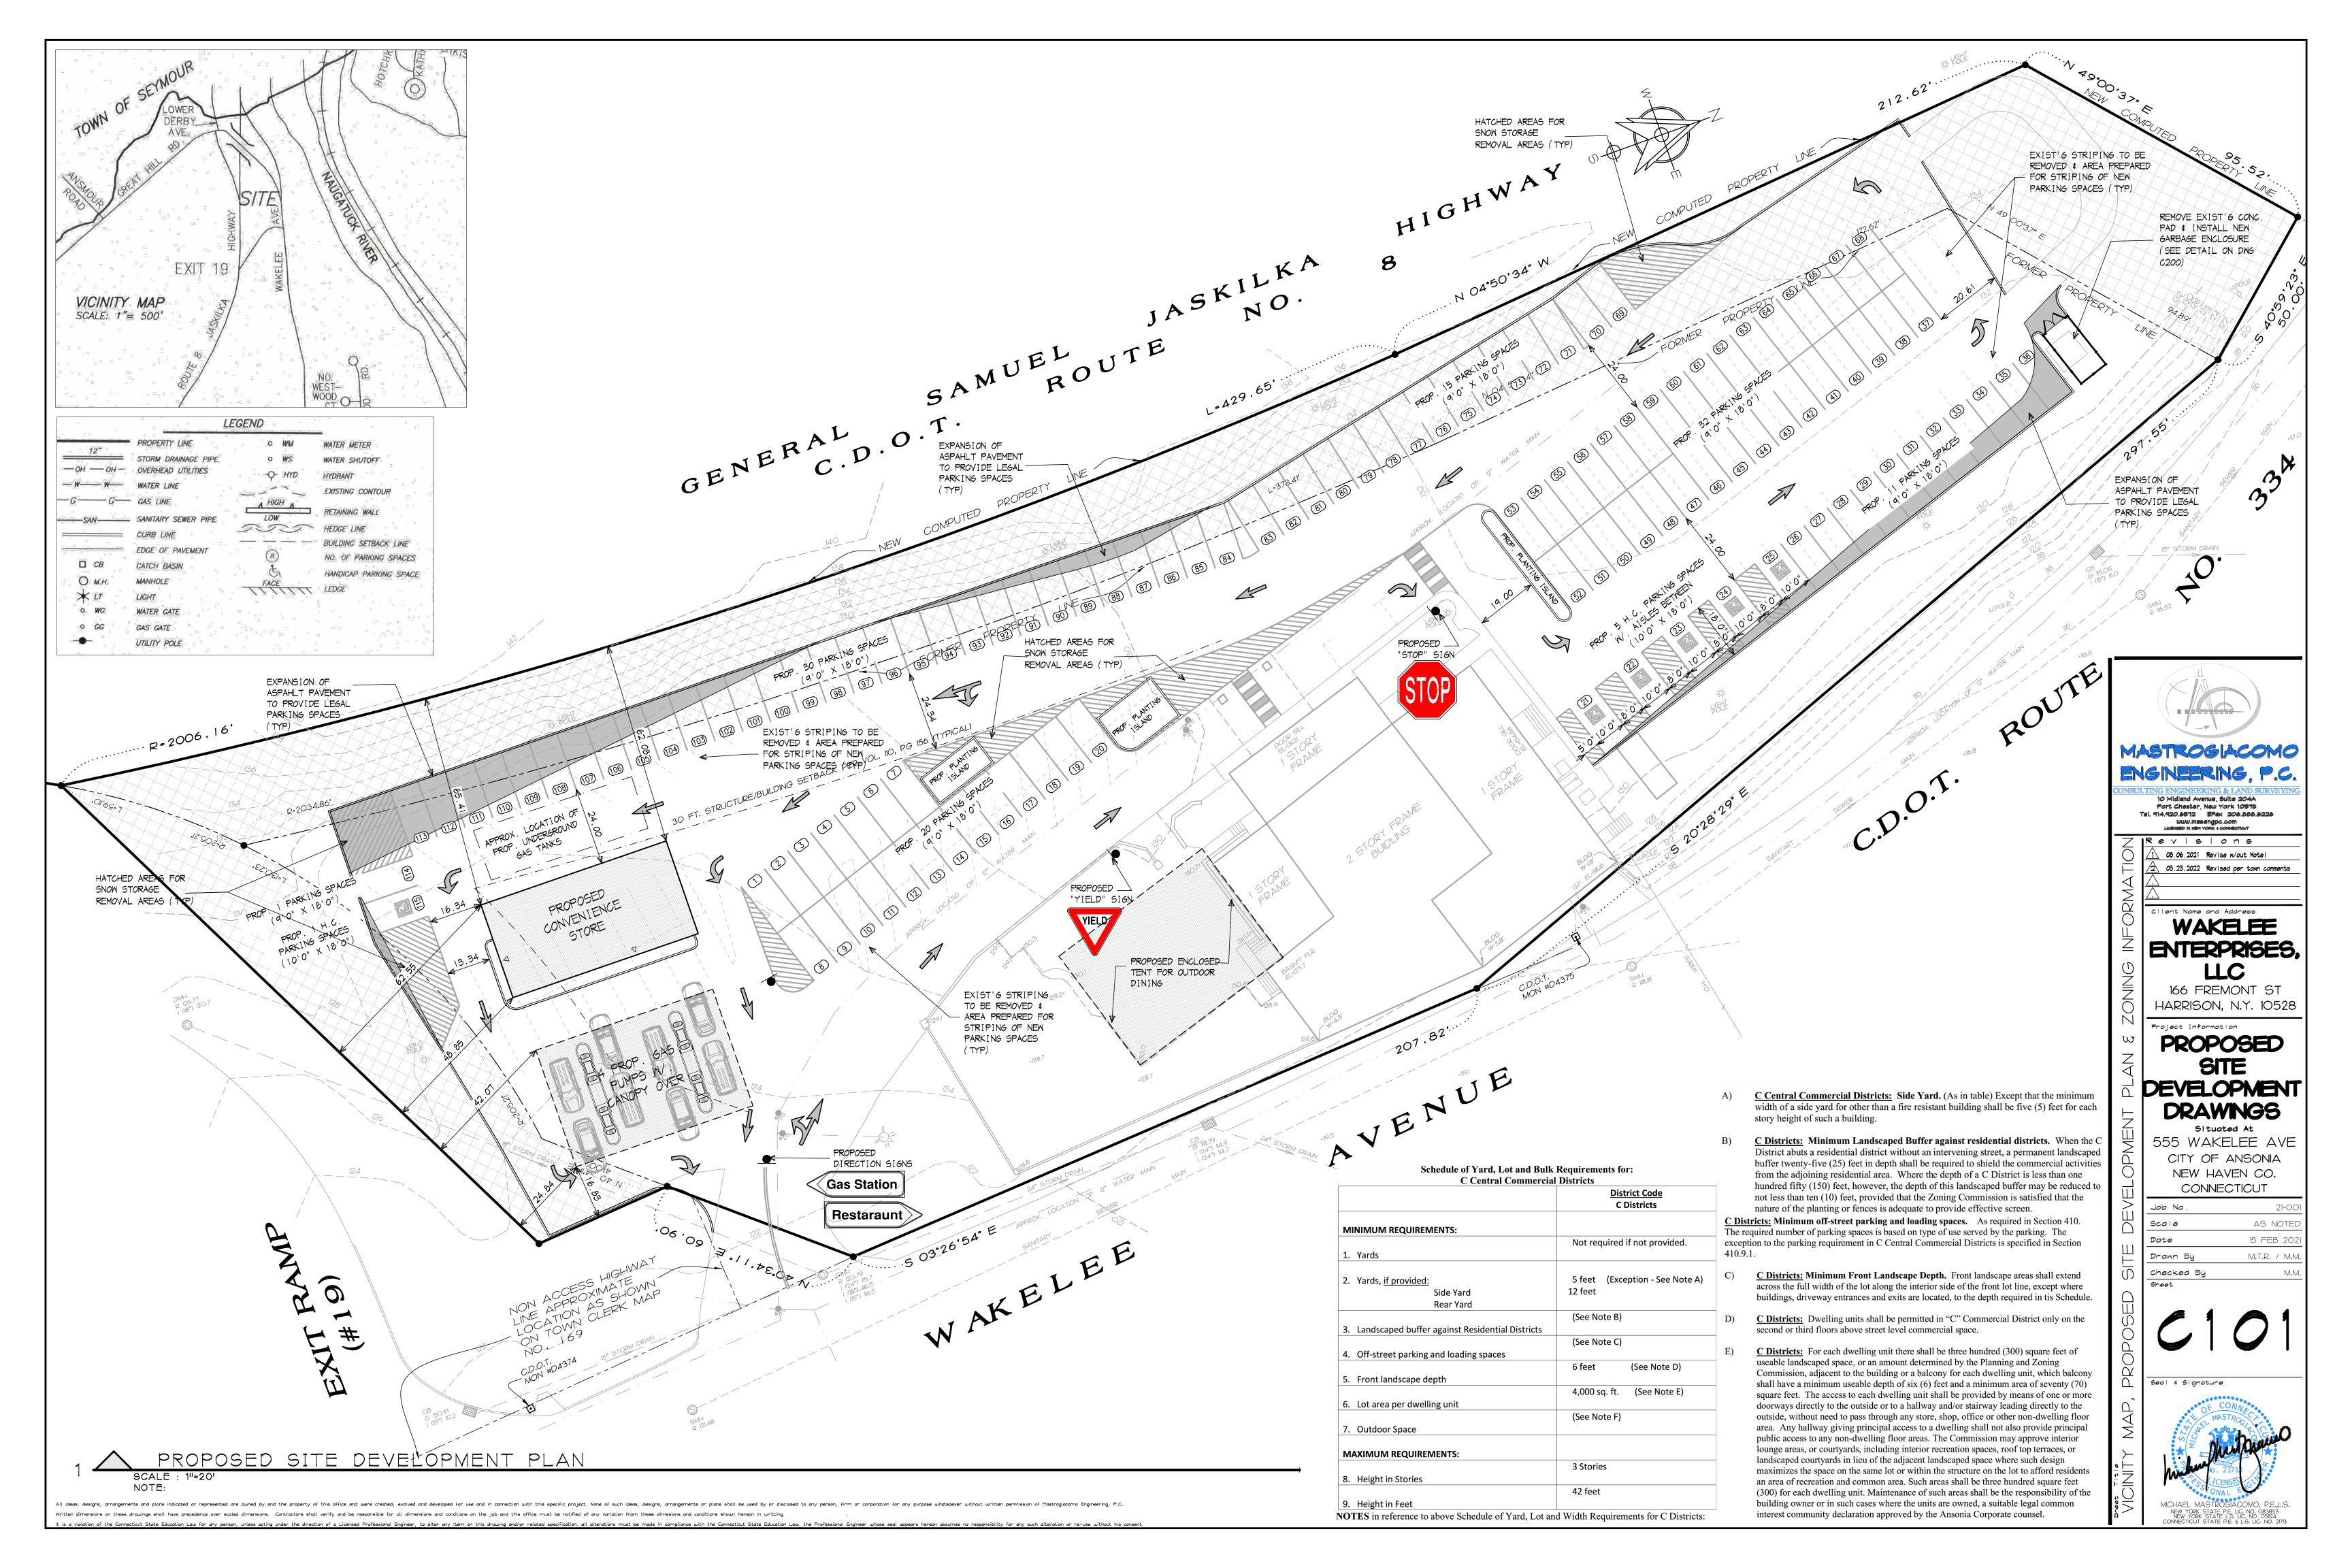


PLANTING NOTES

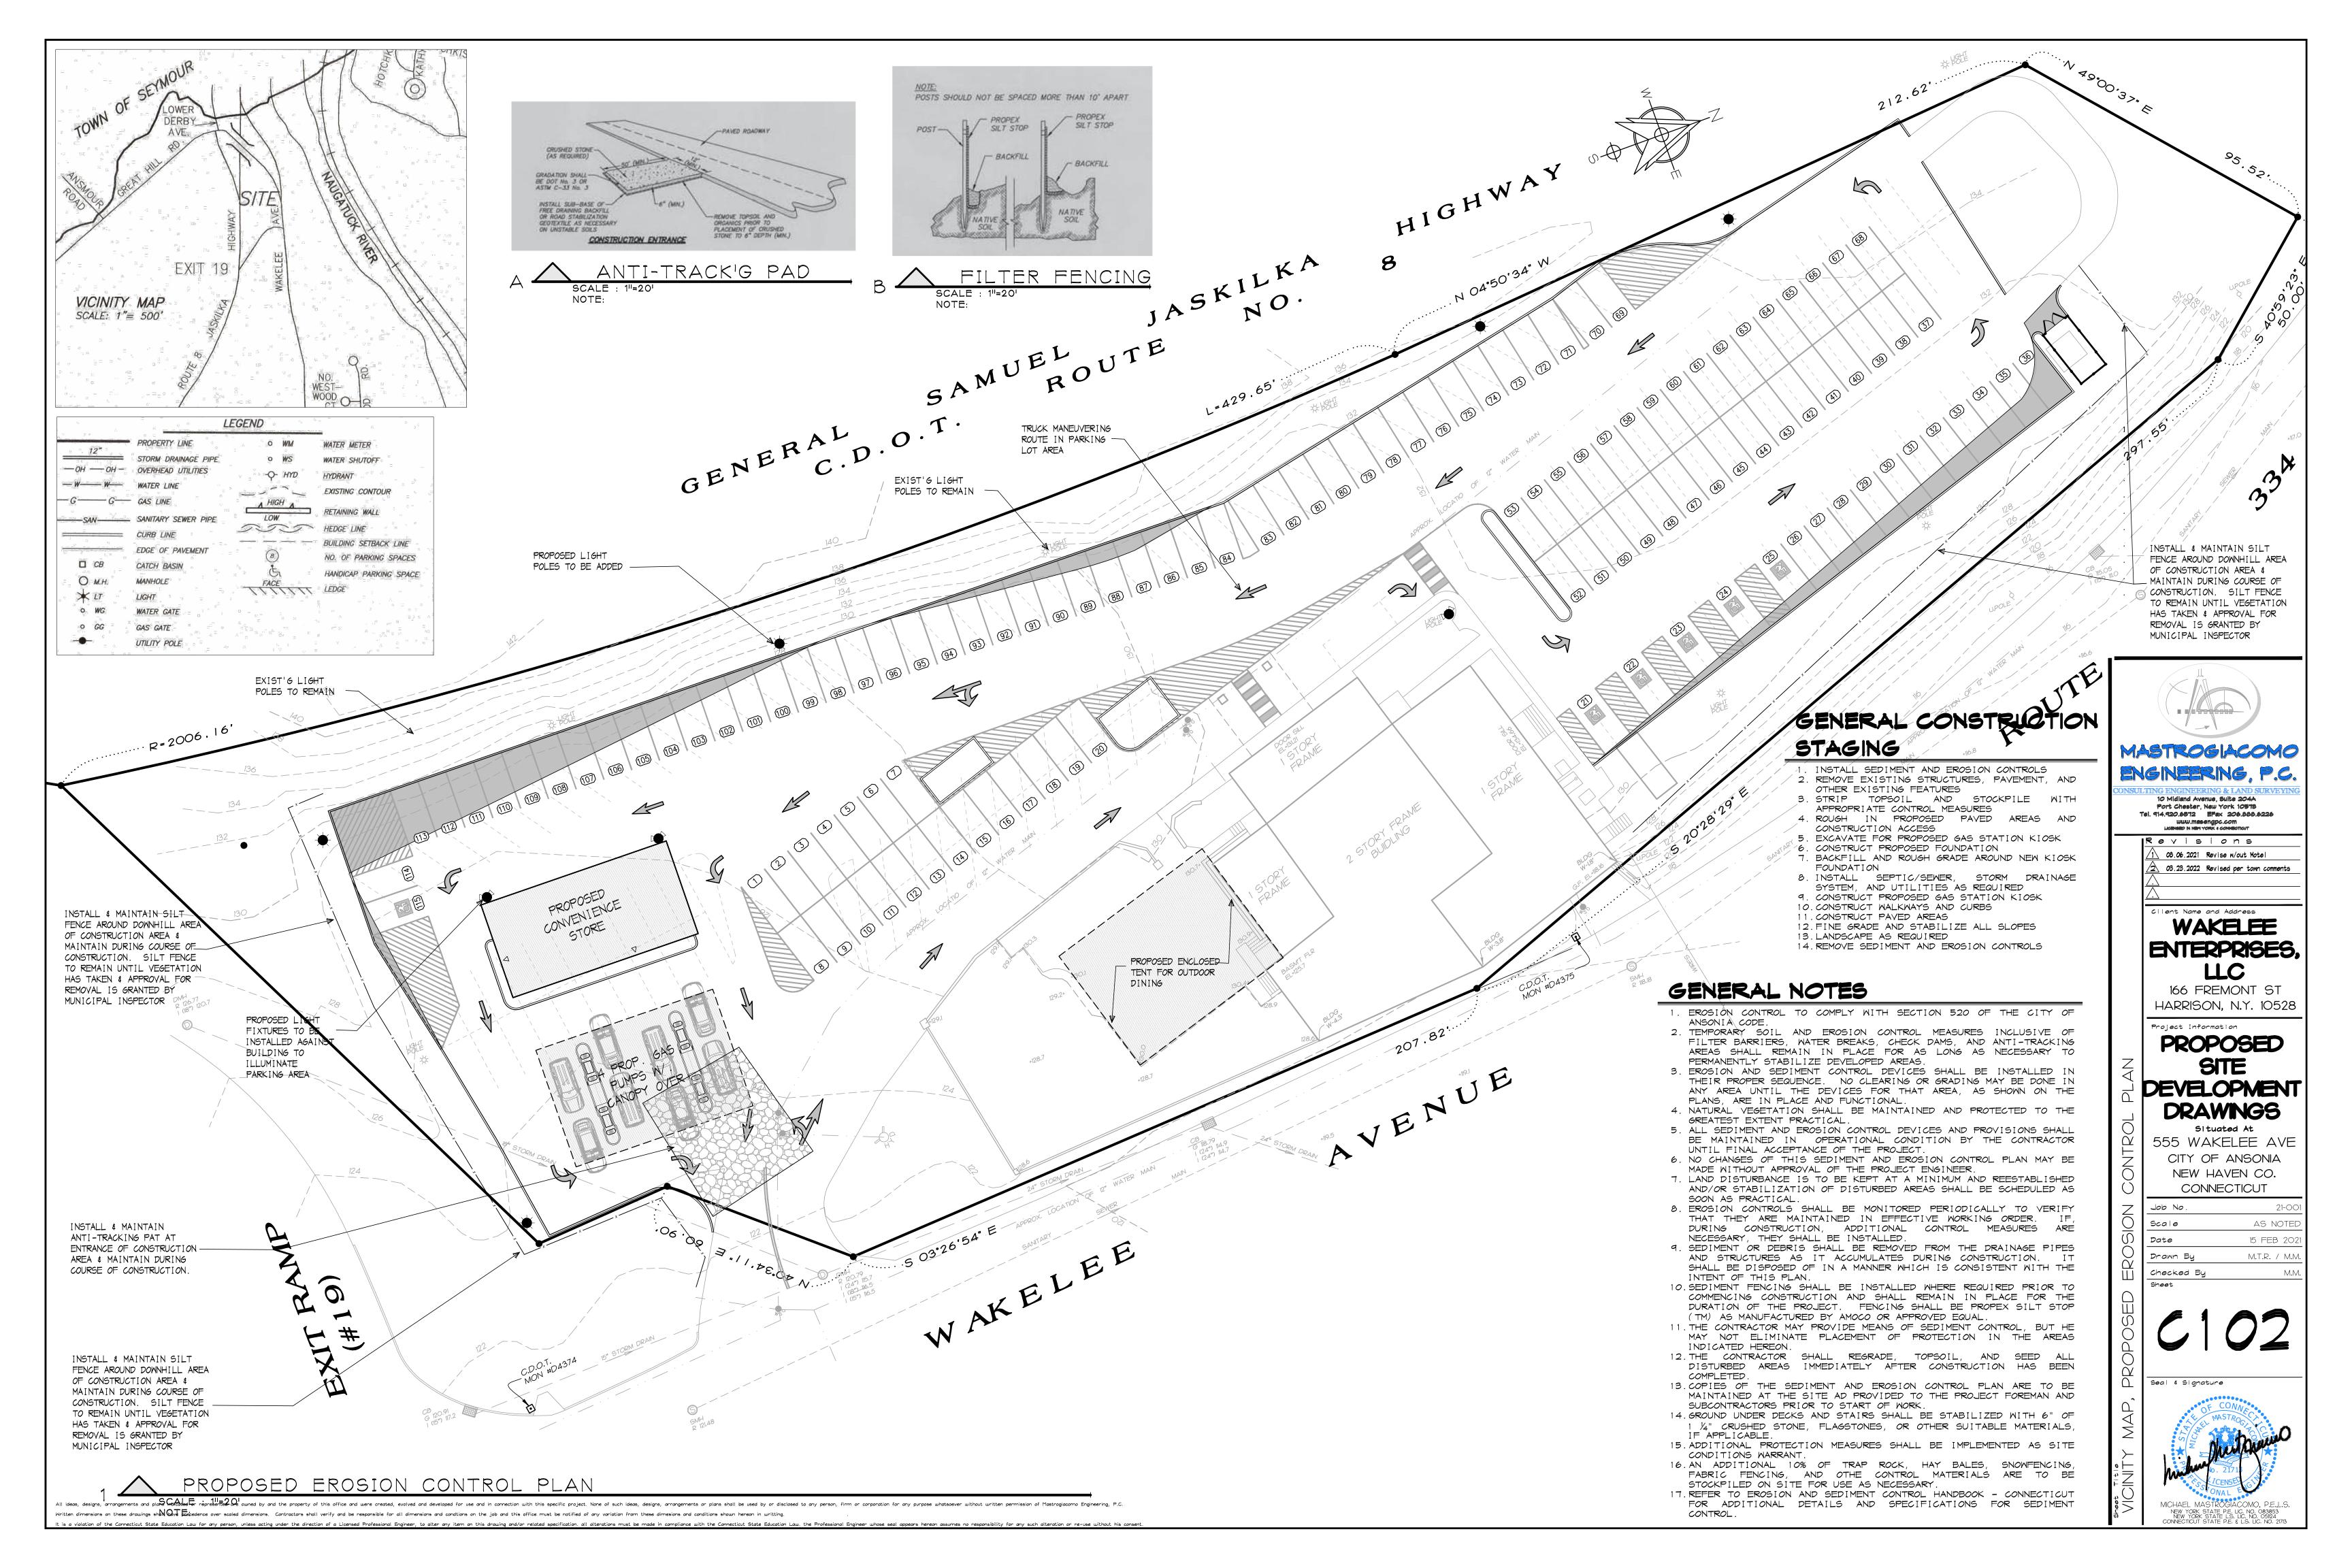- 1. NAMES: AGREE WITH NOMENCLATURE OF STANDARD PLANT NAMES: AMERICAN JOINT COMMITTEE ON HORTICULTURAL NOMENCLATURE, 1942 EDITION. PLANT MATERIAL SHALL BE TRUE TO BOTANICAL NAME, SPECIFIED SIZE, AND IN A VIGOROUS CONDITION.
- 2. SIZE AND GRADING: CONFORM TO AMERICAN ASSOCIATION OF NURSERYMEN STANDARDS,
- 3. QUALITY: TYPICAL OF SPECIES OR VARIETY, NORMAL WELL-DEVELOPED BRANCHES AND VIGOROUS ROOT SYSTEMS. FREE FROM DEFECTS, INJURY, DISEASE OR INSECT INFESTATION.
- 4. FOR MEASUREMENT, A PLANT SHALL BE DIMENSIONED AS IT STANDS IN ITS NORMAL POSITION. TREES CALIPERED 6" ABOVE GROUND. STOCK FURNISHED SHALL BE A FAIR AVERAGE OF MINIMUM AND MAXIMUM SIZE SPECIFIED. LARGE PLANTS CUT BACK TO SIZES SPECIFIED WILL NOT BE ACCEPTED
- 5. NO SUBSTITUTIONS PERMITTED EXCEPT BY WRITTEN PERMISSION OF ENGINEER.
- 6. ALL PLANTING OPERATIONS IN WETLAND AREAS SHALL BE PERFORMED BY HAND METHODS,
- 7. PLANTING OF TREES SHALL BE IN PITS TWICE AS WIDE AS THE DIAMETER OF THE BALL OR ROOT SYSTEM. SUBSOIL FROM PLANTING EXCAVATIONS SHALL BE REMOVED FROM THE SITE.
- 8. TREES SHALL BE PLANTED PLUMB AT THE SAME LEVEL AT WHICH THEY HAVE GROWN, UNLESS OTHERWISE SPECIFIED ON THE DRAWINGS. THE BALLS OF EARTH OF BALLED AND BURLAPED OR CANNED TREES SHALL NOT BE LOOSENED OR OTHERWISE DAMAGED DURING PLANTING OPERATIONS. ALL LARGE AND FLESHY ROOTS WHICH ARE BRUISED OR BROKEN SHALL BE PRUNED WITH A CLEAN CUT BEFORE PLANTING. SOIL SHALL BE FIRMED AT 6" TO 8" INTERVALS AND THOROUGHLY SETTLED WITH WATER.
- 9. ALL AREAS DISTURBED DURING THE CONSTRUCTION PROCESS SHALL BE SEEDED WITH CONSERVATION MIX AND MULCHED WITH SALT HAY.
- 10.ALL TREES SHALL BE STAKED OR GUYED SECURELY IN ACCORDANCE WITH STANDARD PRACTICE. CARE SHALL BE TAKEN SO THAT STAKES AND GUY WIRE WILL NOT CREATE PEDESTRIAN OR VEHICULAR HAZARDS.
- 11. EACH TREE SHALL BE PRUNED TO PRESERVE THE NATURAL SHAPE AND CHARACTER OF THE PLANT. IN GENERAL AT LEAST 1/4 TO 1/3 OF THE WOOD OF DECIDUOUS PLANTS SHALL BE REMOVED BY THINNING THE BRANCHES, BUT NO LEADERS SHALL BE CUT.
- 12. ALL SOFT WOOD OR SUCKER GROWTH AND ALL BROKEN, DEAD, OR BADLY BRUISED BRANCHES SHALL BE REMOVED WITH CLEAN CUTS.
- 13. ALL TREES SHALL BE THOROUGHLY WATERED DURING AND AFTER PLANTING OPERATIONS AS WEATHER CONDITIONS REQUIRE FOR THE ENTIRE MAINTENANCE PERIOD. DUE CARE SHALL BE EXERCISED TO AVOID "WASHING OUT" OF THE MULCHED SOIL. MINIMUM WATER IS CONSIDERED AS ONE SOAKING PER WEEK.
- 14. MAINTAIN ALL PLANTED TREES UNTIL ALL WORK UNDER CONSTRUCTION IS APPROVED AND ACCEPTED.
- 15.MAINTENANCE SHALL INCLUDE WATERING, WEEDING, CULTIVATION, AND PRUNING, ADJUSTMENT AND REPAIR OF STAKES, ANCHORS AND WIRES, REPAIR OF MINOR WASHOUTS AND GULLIES AND OTHER HORTICULTURAL OPERATIONS NECESSARY FOR THE PROPER GROWTH OF PLANTS AND MAINTAINING A NEAT APPEARANCE OF ALL WORK UNDER CONTRACT.
- 16. REPLACEMENTS SHALL BE MADE AT THE COMPLETION OF THE GUARANTEE PERIOD.
- 17.ALL REPLACEMENTS OF UNHEALTHY, DEAD, DYING, DISFIGURED PLANTS (IN THE OPINION OF THE ENGINEER) SHALL BE PLANTS OF THE SAME SPECIES AND SIZE AS SPECIFIED IN THE PLANT LIST. THEY SHALL BE FURNISHED AND PLANTED IN ACCORDANCE WITH THESE SPECIFICATIONS. COSTS SHALL BE BORNE BY CONTRACTOR EXCEPT FOR POSSIBLE REPLACEMENTS RESULTING FROM REMOVAL, LOSS OR DAMAGE DUE TO OCCUPANCY OF THE PROJECT IN ANY PART, VANDALISM OR ACTS OF OF NEGLECT ON THE PART OF THE OWNER OR OTHERS, PHYSICAL DAMAGE BY ANIMALS, VEHICLES, FIRE, ETC. OR LOSSES DUE TO "ACTS OF GOD" (FLOODS, CYCLONES, HURRICANES, ETC.). THE OWNER SHALL ASSUME THE RISK OF SUCH "ACTS OF GOD"

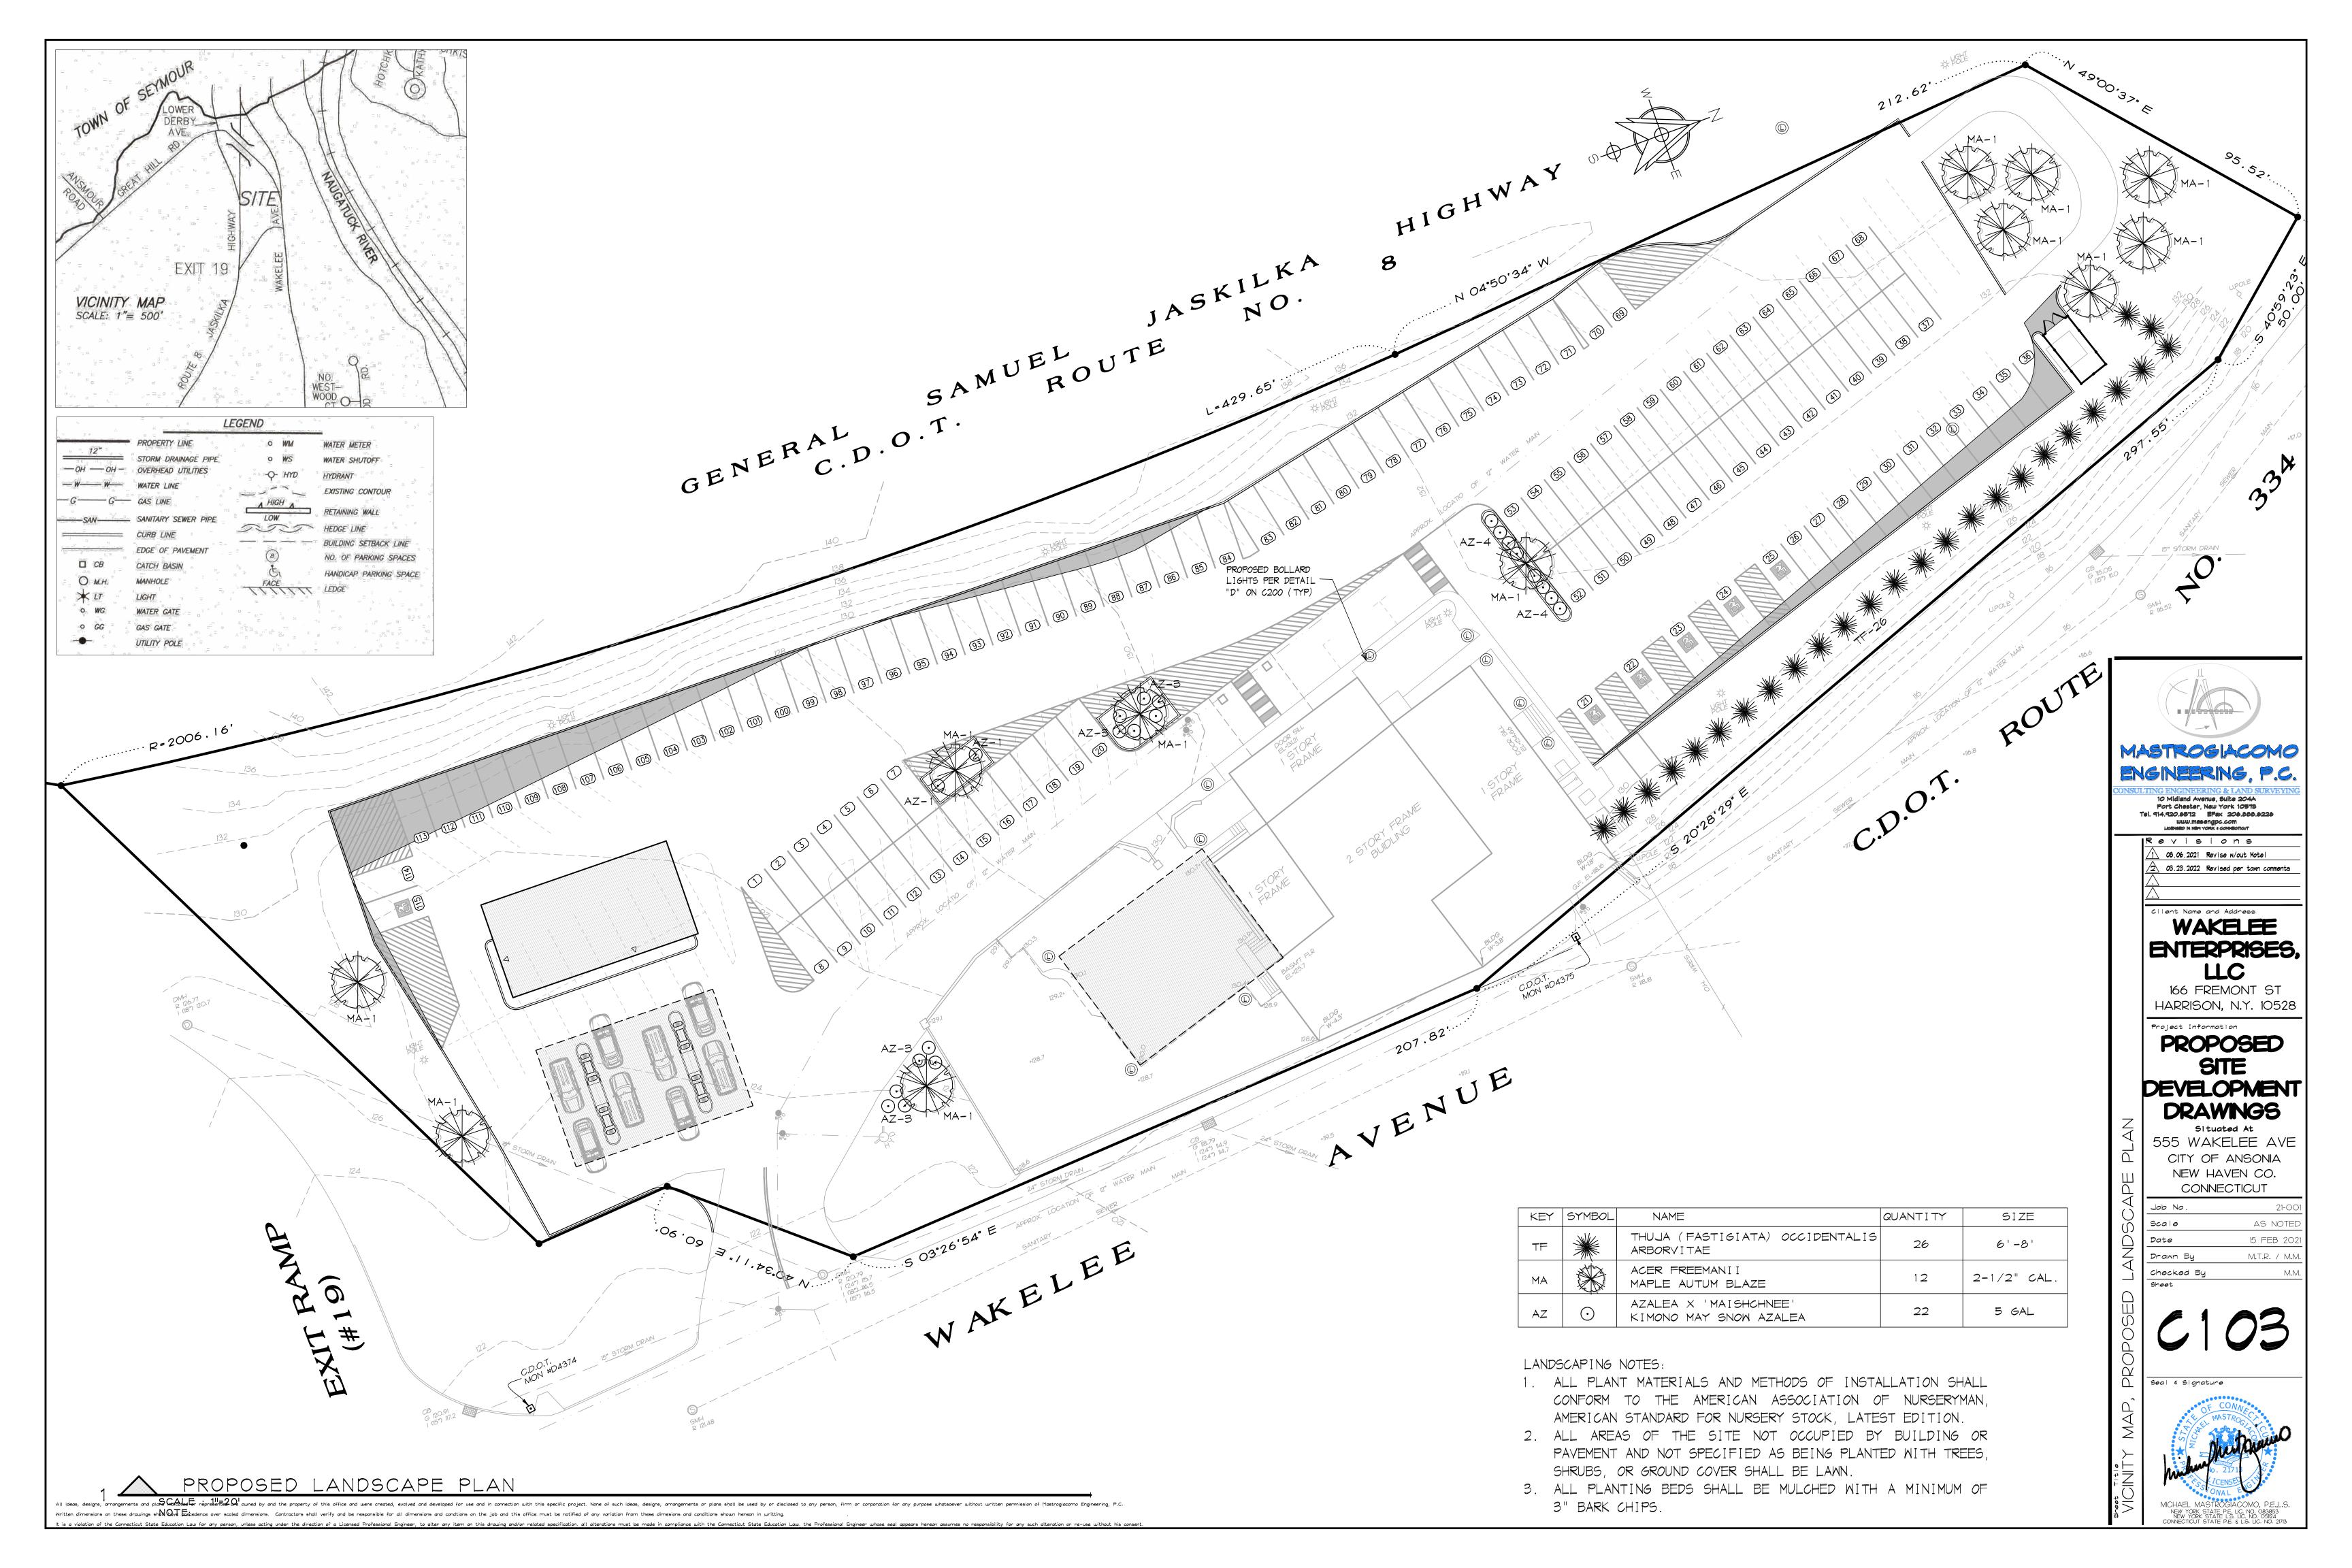




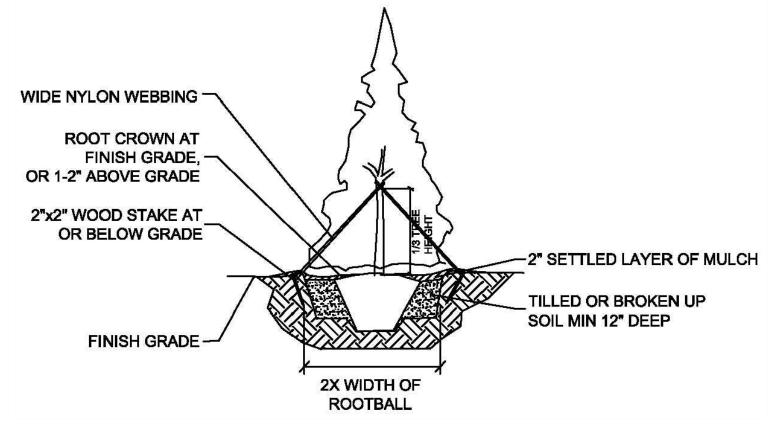

NOTES: EVERGREEN TREE PLANTING

- 1. ALL PLANT MATERIALS SHALL BE IN ACCORDANCE WITH THE AMERICAN STANDARDS FOR NURSERY STOCK (ANSI Z60.1-2004). PLANT ACCORDING TO ANSI A300 PART
- 2. DIG THE PLANTING HOLE A MINIMUM OF 2X WIDTH OF ROOTBALL FOR AT LEAST THE FIRST 12 INCHES OF DEPTH. BELOW 12 INCHES, DIG HOLE WIDE ENOUGH TO
- PERMIT ADJUSTING. DO NOT DIG THE HOLE DEEPER THAN ROOT BALL DEPTH. 3. SCARIFY THE SUBGRADE AND SIDES OF THE PLANTING HOLE WHEN PLANTING IN CLAY SOILS (MORE THAN 15% CLAY).
- 4. LIFT AND SET THE TREE BY ROOT BALL ONLY. DO NOT LIFT USING THE TREE TRUNK AND DO NOT USE TREE TRUNK AS A LEVER.
- 5. SET THE TOP OF THE ROOT BALL LEVEL WITH THE SOIL SURFACE OR SLIGHTLY
- HIGHER IF THE SOIL IS PRONE TO SETTLING.
- 6. AFTER THE TREE IS SET IN PLACE, REMOVE BURLAP, WIRE AND STRAPS FROM AT LEAST THE UPPER 1/3 OF THE ROOTBALL 7. BACKFILL WITH EXISTING SOIL THAT HAS BEEN WELL-TILLED OR BROKEN UP. DO NOT ADD AMENDMENTS TO THE BACKFILL SOIL. AMEND THE SURFACE WITH MULCH.
- 8. USE THREE 2" X 2" WOOD STAKES DRIVEN INTO UNDISTURBED SOIL A MINIMUM OF 16 INCHES. SPACE STAKES EQUALLY AROUND THE TREE. 9. ATTACH 3/4" NYLON WEBBING TO CONNECT THE TREE TO STAKES. ATTACH WEBBING AT 1/3 THE TREE HEIGHT.
- 10. APPLY A 2-3" (SETTLED) DEPTH OF PINE STRAW OR BARK MULCH TO THE PLANTING SURFACE. LEAVE A 2" SPACE AROUND THE TRUNK FOR AIR CIRCULATION.
- 11. PRUNING SHALL BE LIMITED TO DEAD, DISEASED, OR BROKEN LIMBS ONLY AND SHALL BE IN ACCORDANCE WITH ANSI A300 SPECIFICATIONS.
- 12. REMOVE ANY TRUNK WRAP REMAINING AT TIME OF PLANTING. NO WRAPS SHALL BE PLACED ON TRUNK.

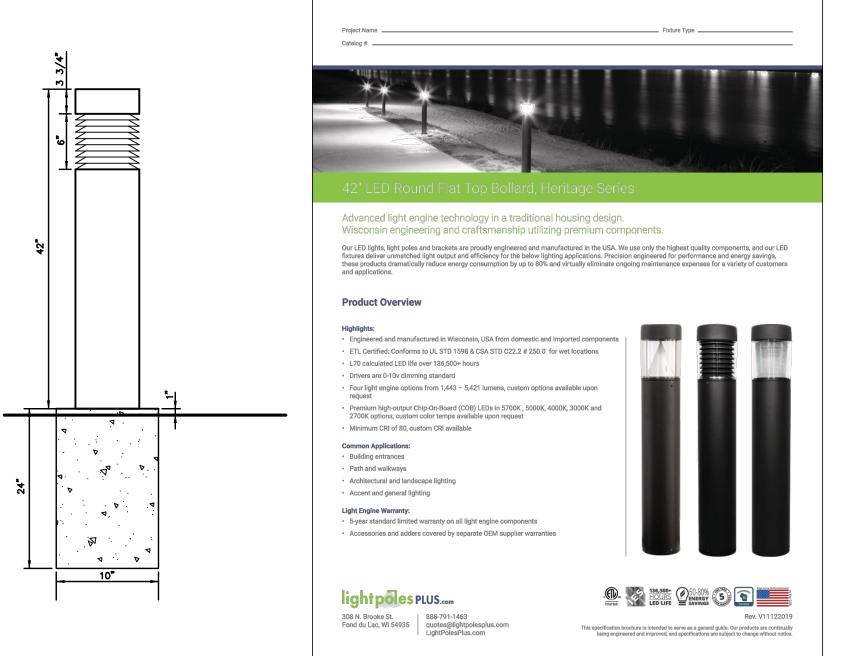

BOLLARD ILLUMINAIRE DETAI

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Revisions ∑ 08.06.2021 Revise m/out Motel 03.23.2022 Revised per town comments

WAKELEE

ENTERPRISES

166 FREMONT ST HARRISON, N.Y. 10528

Project Information


PROPOSED DEVELOPMENT **DRAWINGS**


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AS NOTE 15 FEB 2C M.T.R. / M.N

Checked By

Seal & Signature



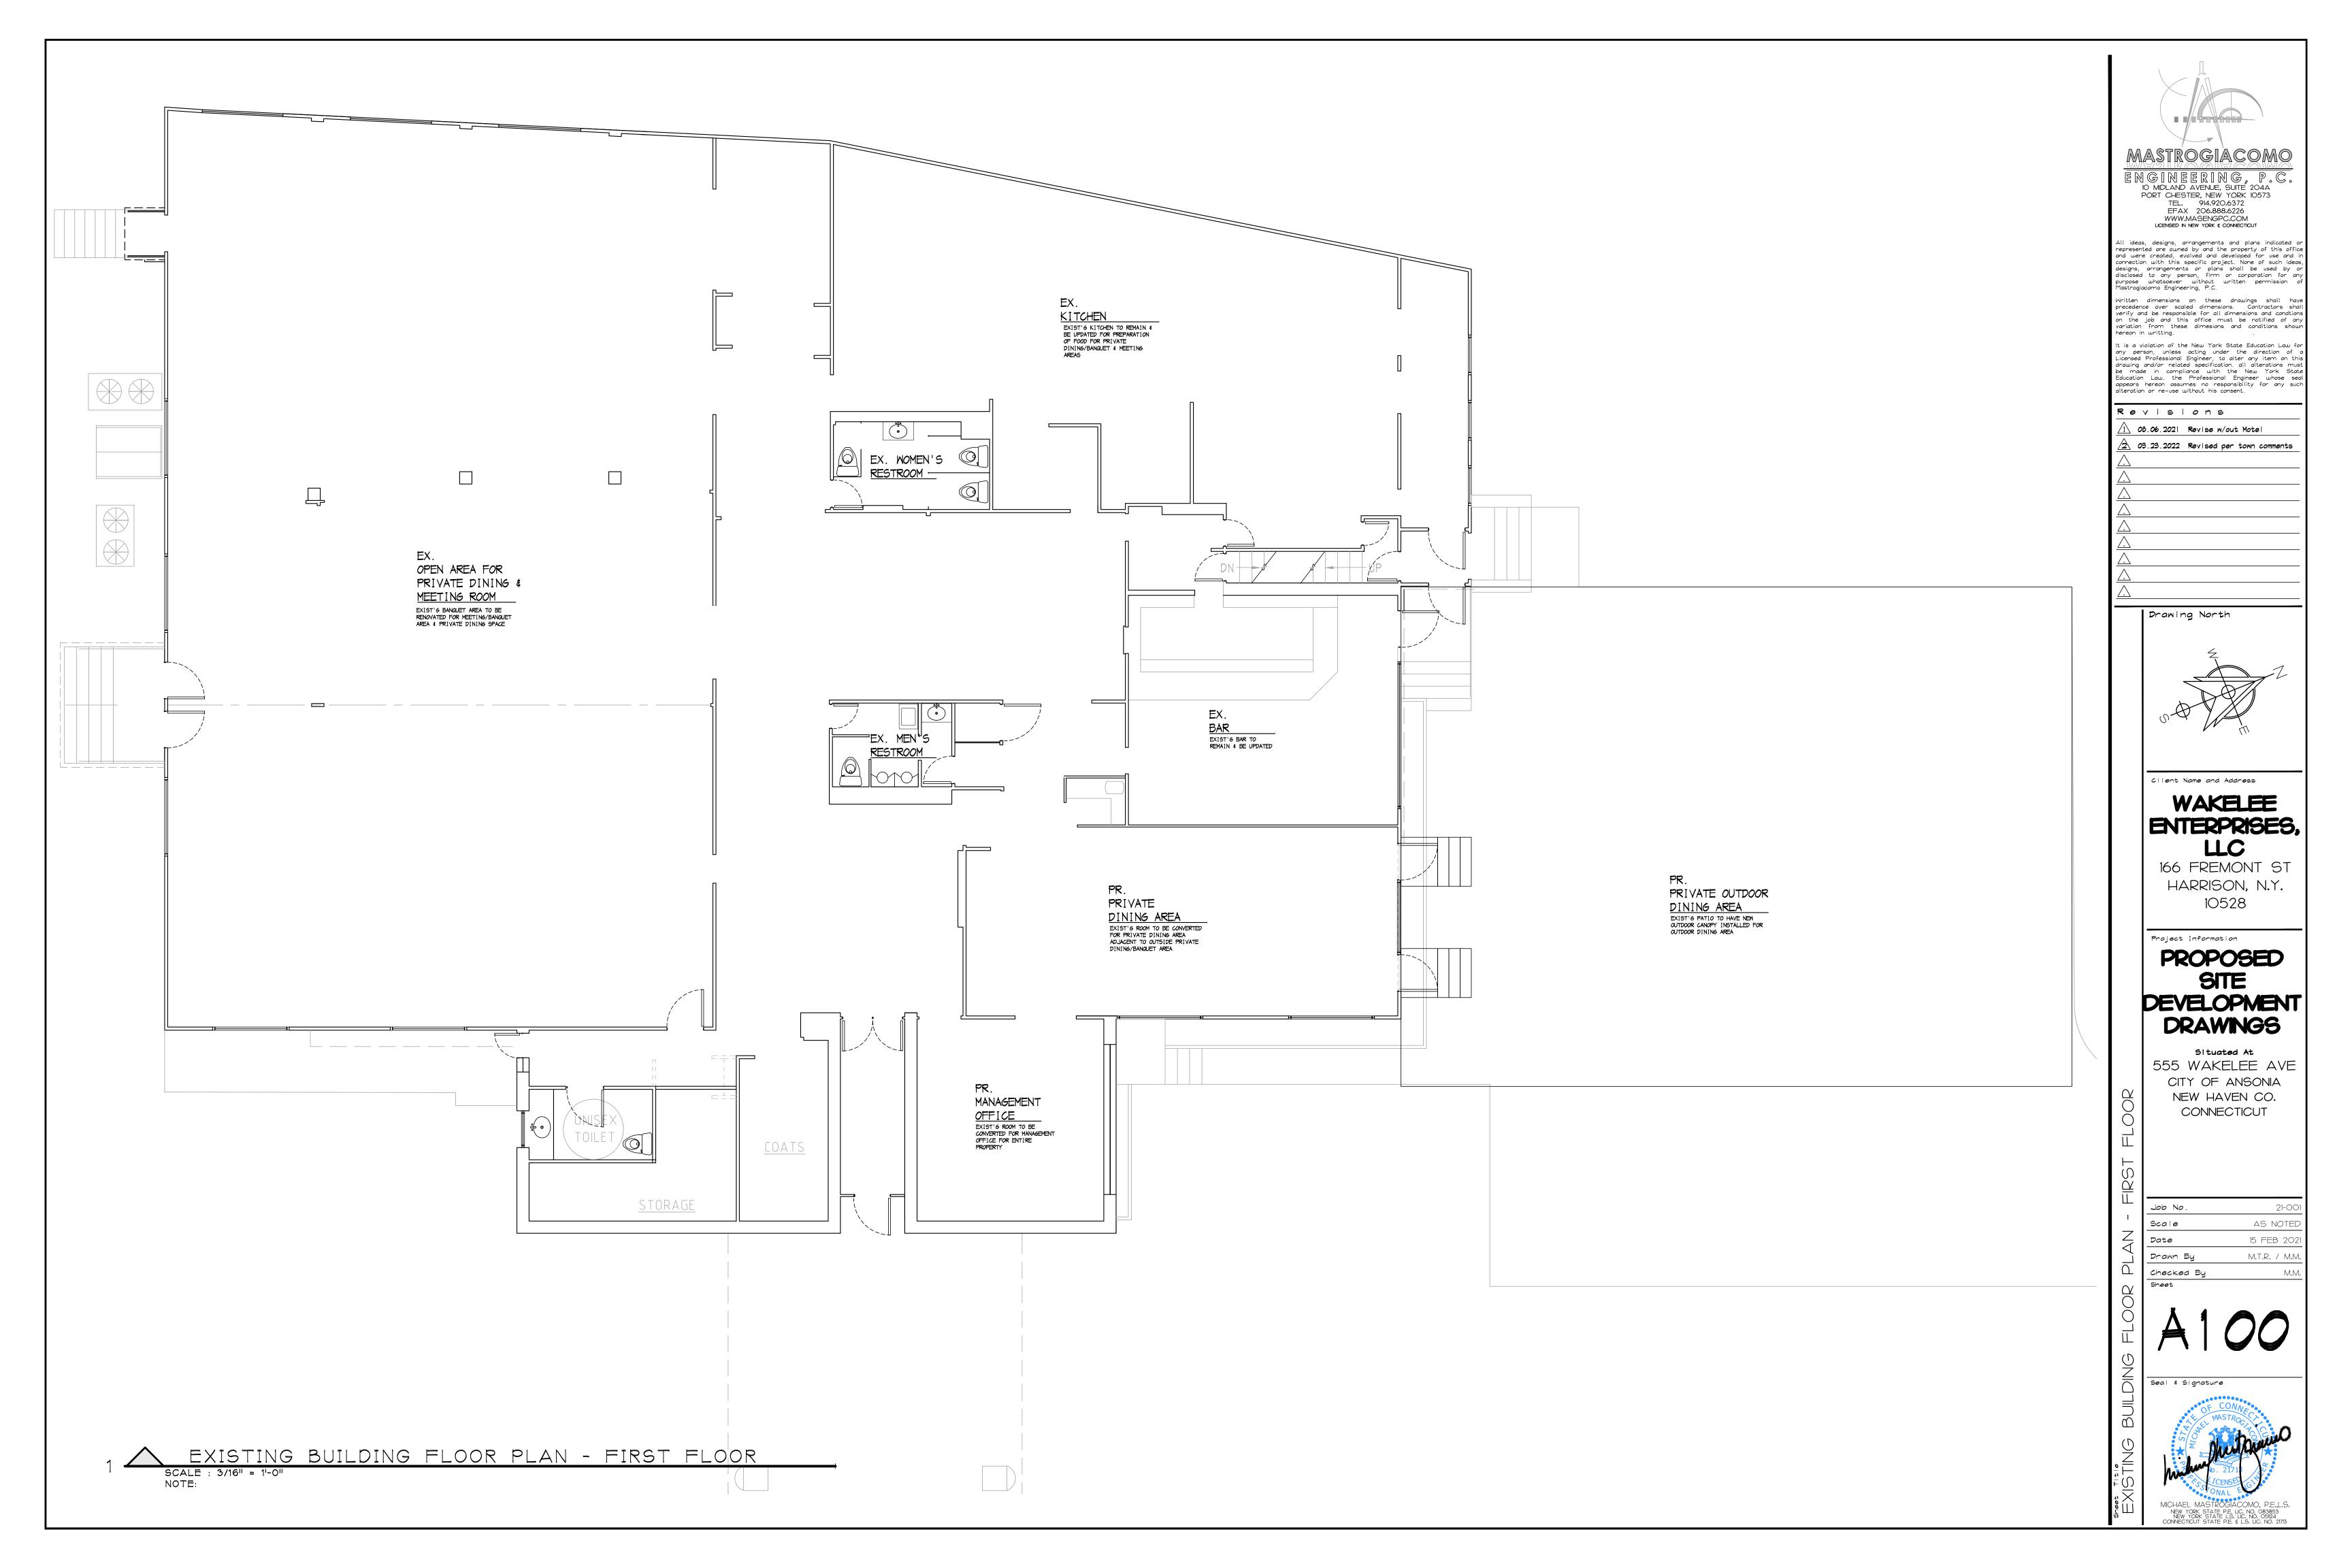

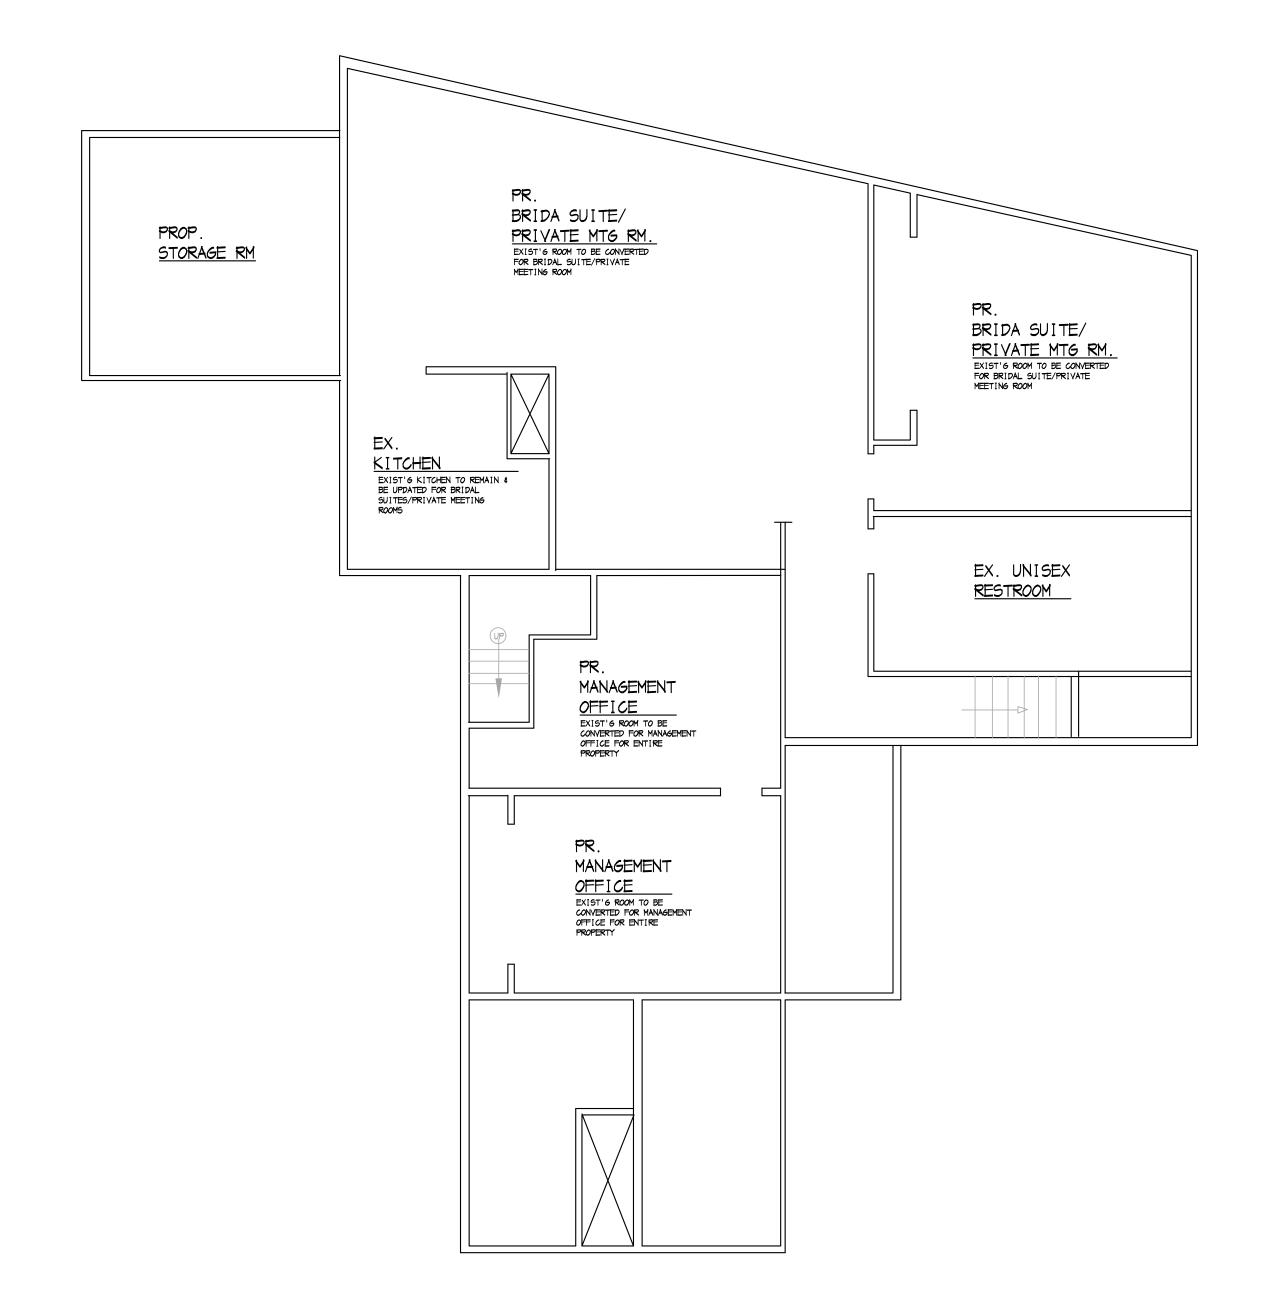


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Revisions $\sqrt{1}$ 08.06.2021 Revise w/out Motel 2 03.23.2022 Revised per town comments

Drawing North



Client Name and Address

WAKELEE ENTERPRISES, LLC

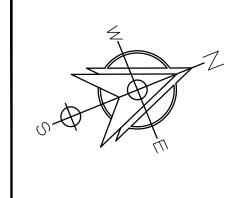166 FREMONT ST HARRISON, N.Y. 10528


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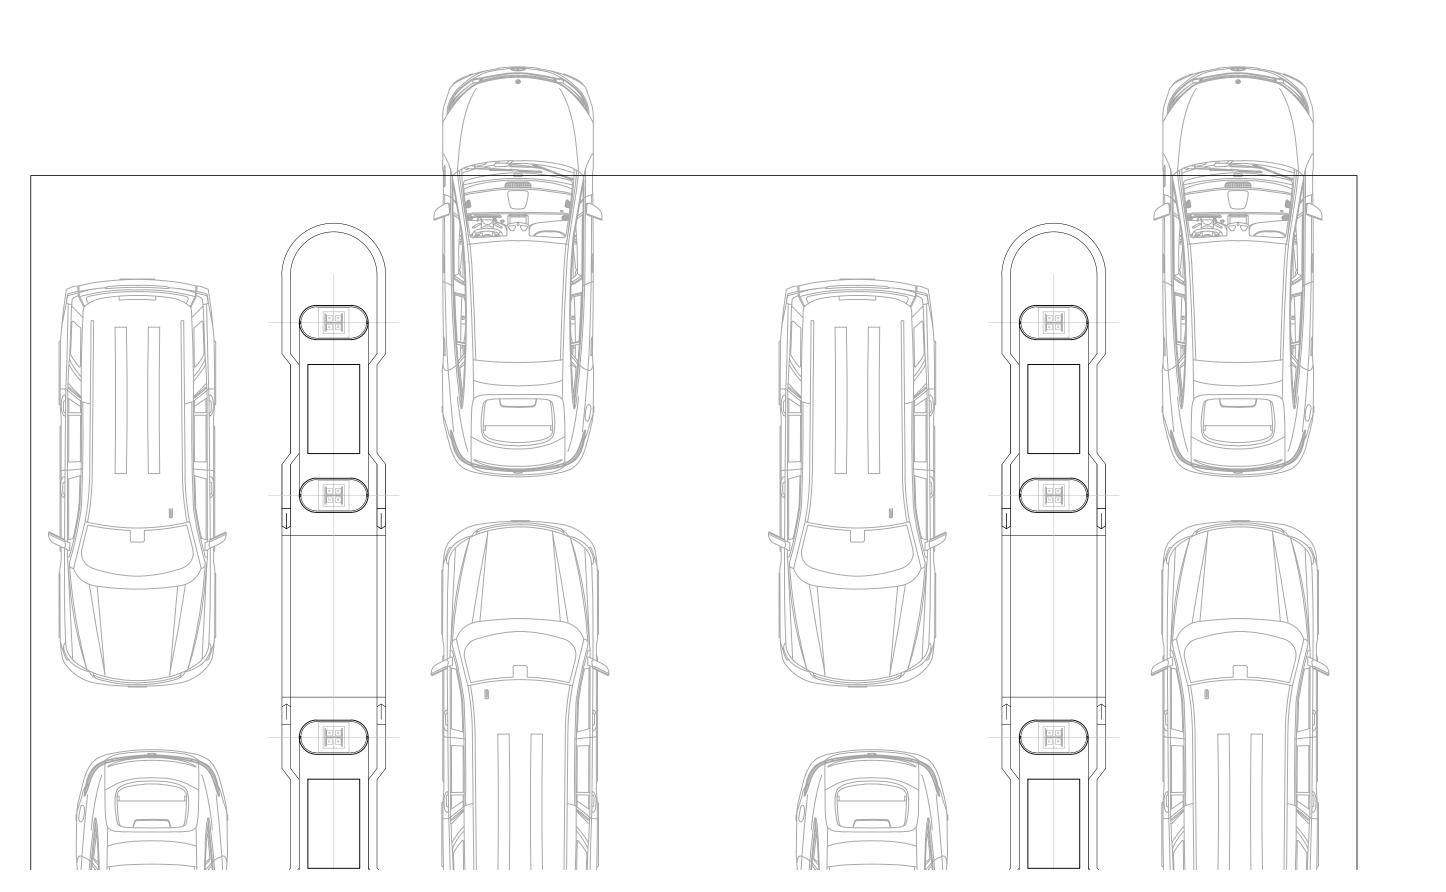
PROPOSED SITE DEVELOPMENT DRAWINGS

situated At 555 WAKELEE AVE CITY OF ANSONIA NEW HAVEN CO. CONNECTICUT

2ND AS NOTE 15 FEB 20 M.T.R. / M.M Checked By

EXISTING BUILDING FLOOR PLAN - SECOND FLOOR SCALE : 3/16" = 1'-0" NOTE:



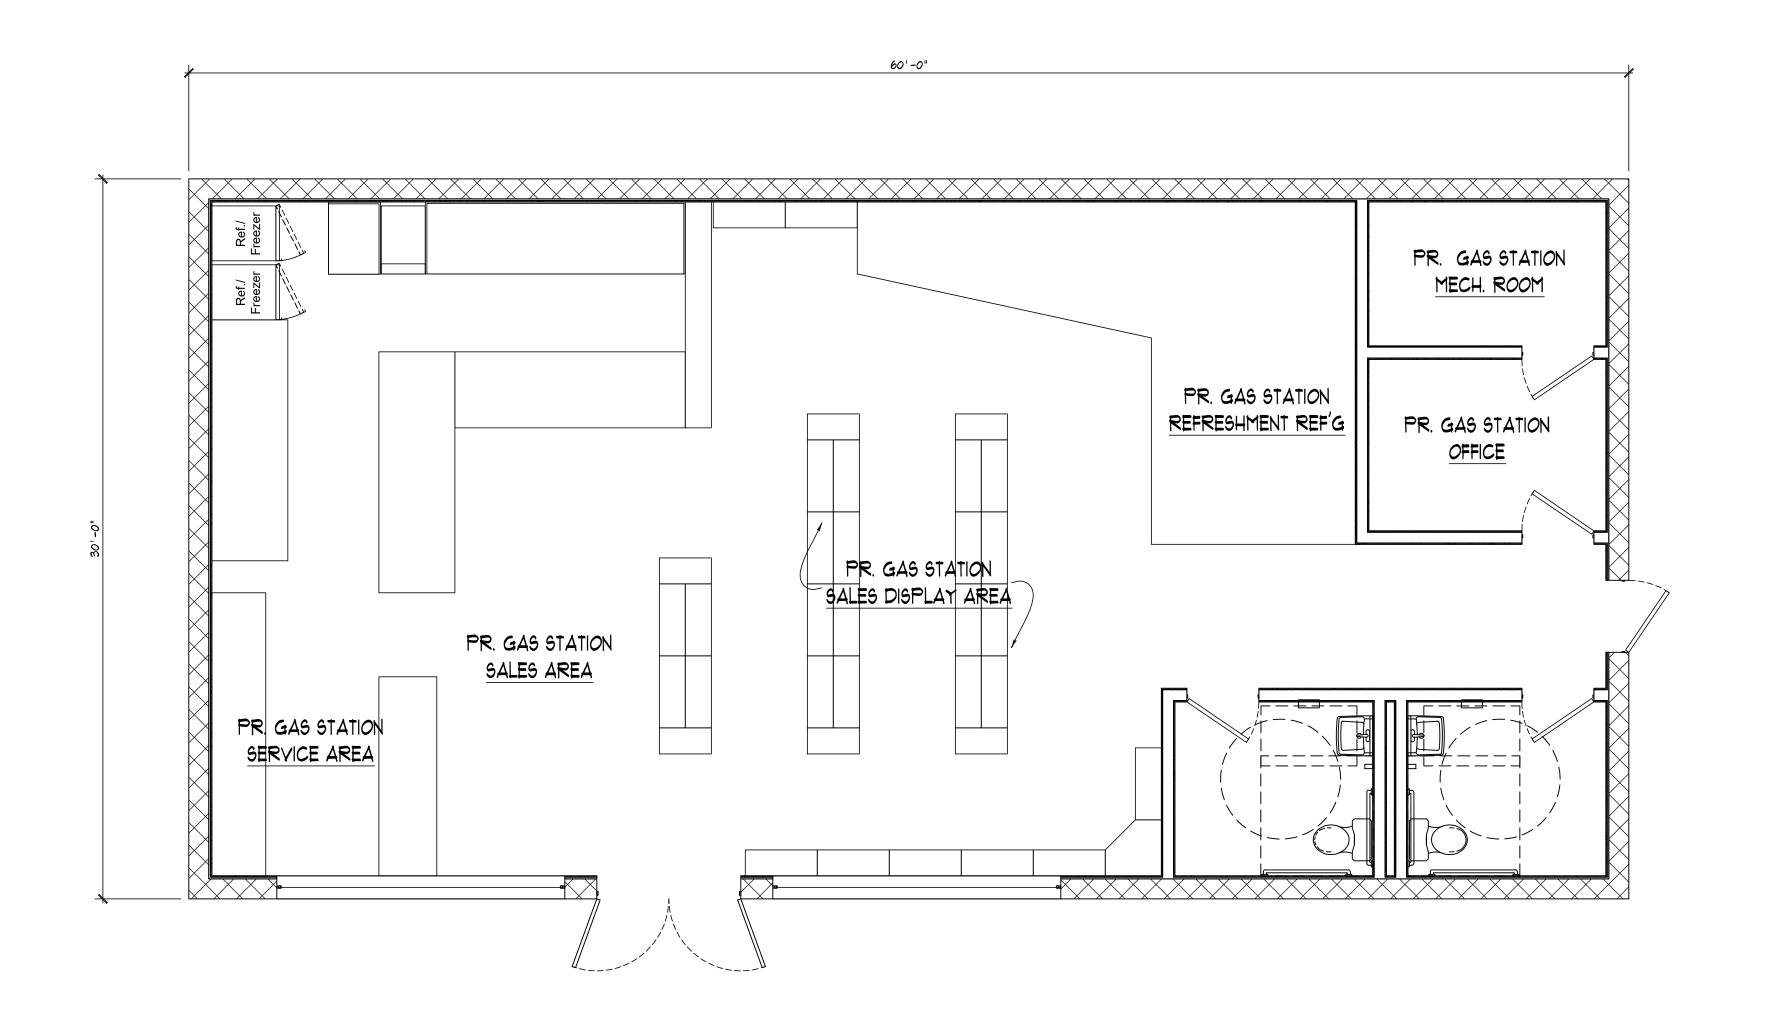



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 Revise vise wout Motel

 ⚠ 03.06.2021 Revise wout Motel

 ⚠ 03.23.2022 Revised per town comments

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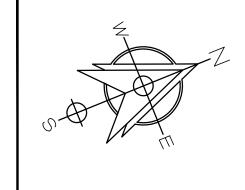
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Drawing North



Client Name and Address

WAKELEE ENTERPRISES,

LLC 166 FREMONT ST HARRISON, N.Y. 10528

Project Information

PROPOSED SITE DEVELOPMENT DRAWINGS

51 tuated At
555 WAKELEE AVE
CITY OF ANSONIA
NEW HAVEN CO.
CONNECTICUT

Job No. 21-00
Scale AS NOTED

Pate 15 FEB 202

Drawn By M.T.R. / M.N.
Checked By M.N.

A200

Seal & Sign




PROPOSED GAS STATION/ CONV. STORE PLAN

SCALE: 1/4" = 1'-0"

NOTE:



PROPOSED FRONT ELEVTION

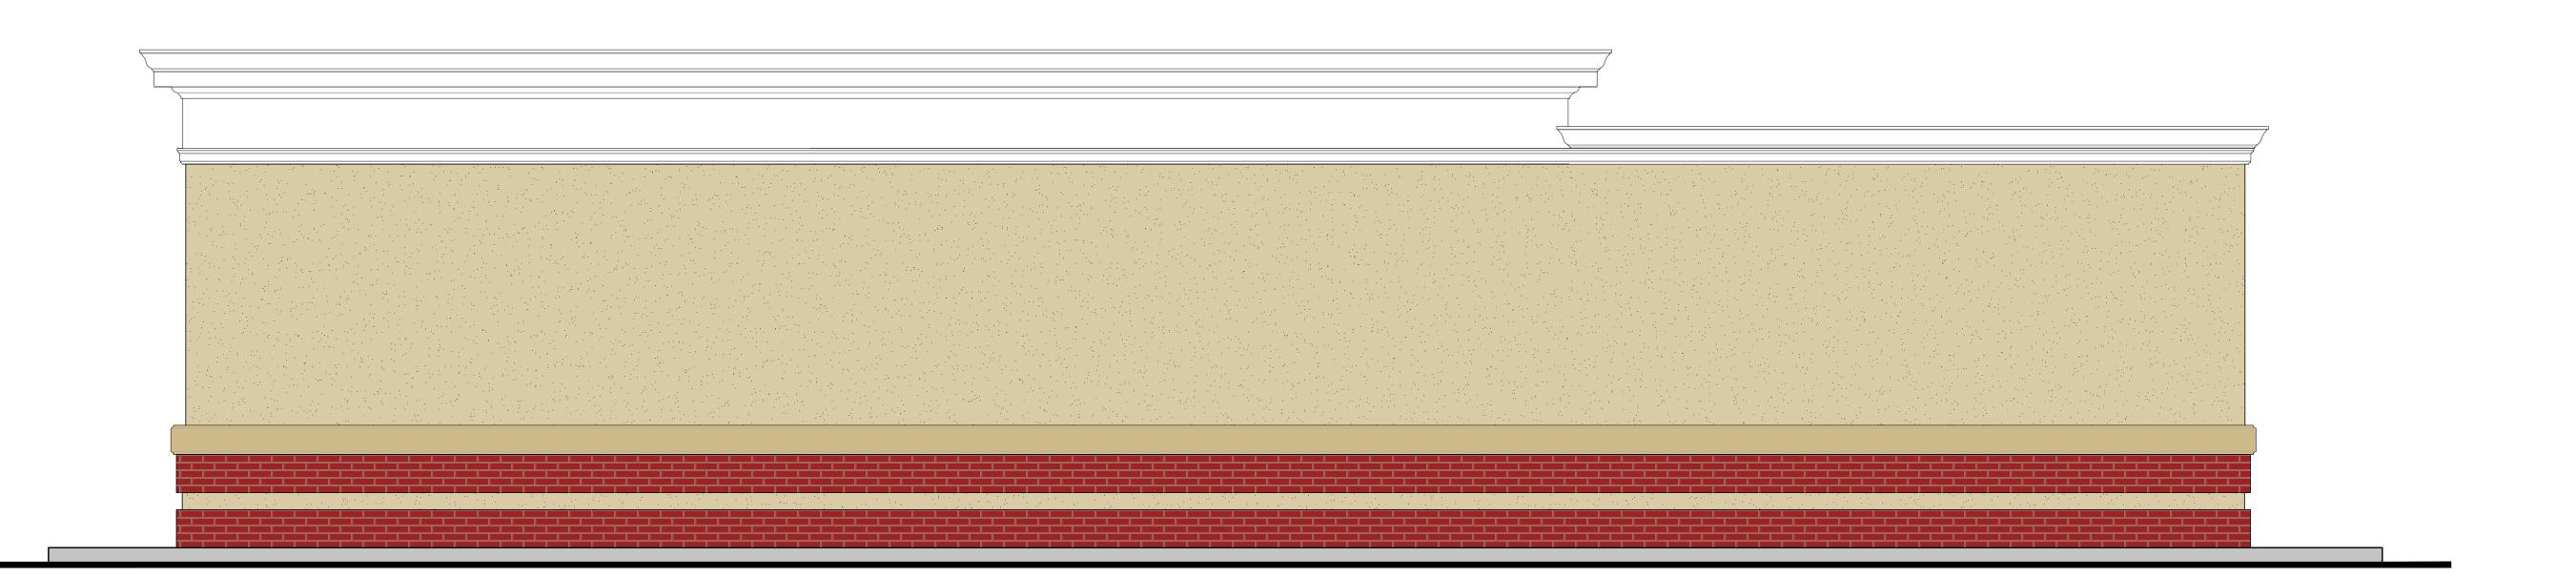

MASTROGIACOMO ENGINEERING, P.C.

10 MIDLAND AVENUE, SUITE 204A
PORT CHESTER, NEW YORK 10573
TEL. 914.920.6372
EFAX 206.888.6226
WWW.MASENGPC.COM
LICENSED IN NEW YORK & CONNECTICUT


All ideas, designs, arrangements and plans indicated or represented are owned by and the property of this office and were created, evolved and developed for use and in connection with this specific project. None of such ideas, designs, arrangements or plans shall be used by or disclosed to any person, firm or corporation for any purpose whatsoever without written permission of Mastrogiacomo Engineering, P.C.

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Revisions 1\ 08.06.2021 Revise w/out Motel 2 03.23.2022 Revised per town comments

Drawing North



Client Name and Address

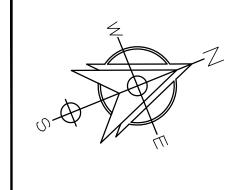WAKELEE ENTERPRISES, LLC

166 FREMONT ST HARRISON, N.Y. 10528

Project Information


PROPOSED SITE | DEVELOPMENT DRAWINGS

Situated At 555 WAKELEE AVE CITY OF ANSONIA NEW HAVEN CO. CONNECTICUT

AS NOTE 15 FEB 20 Drawn By M.T.R. / M.N Checked By

PROPOSED REAR ELEVATION

SCALE : 3/8" = 1'-0" NOTE:

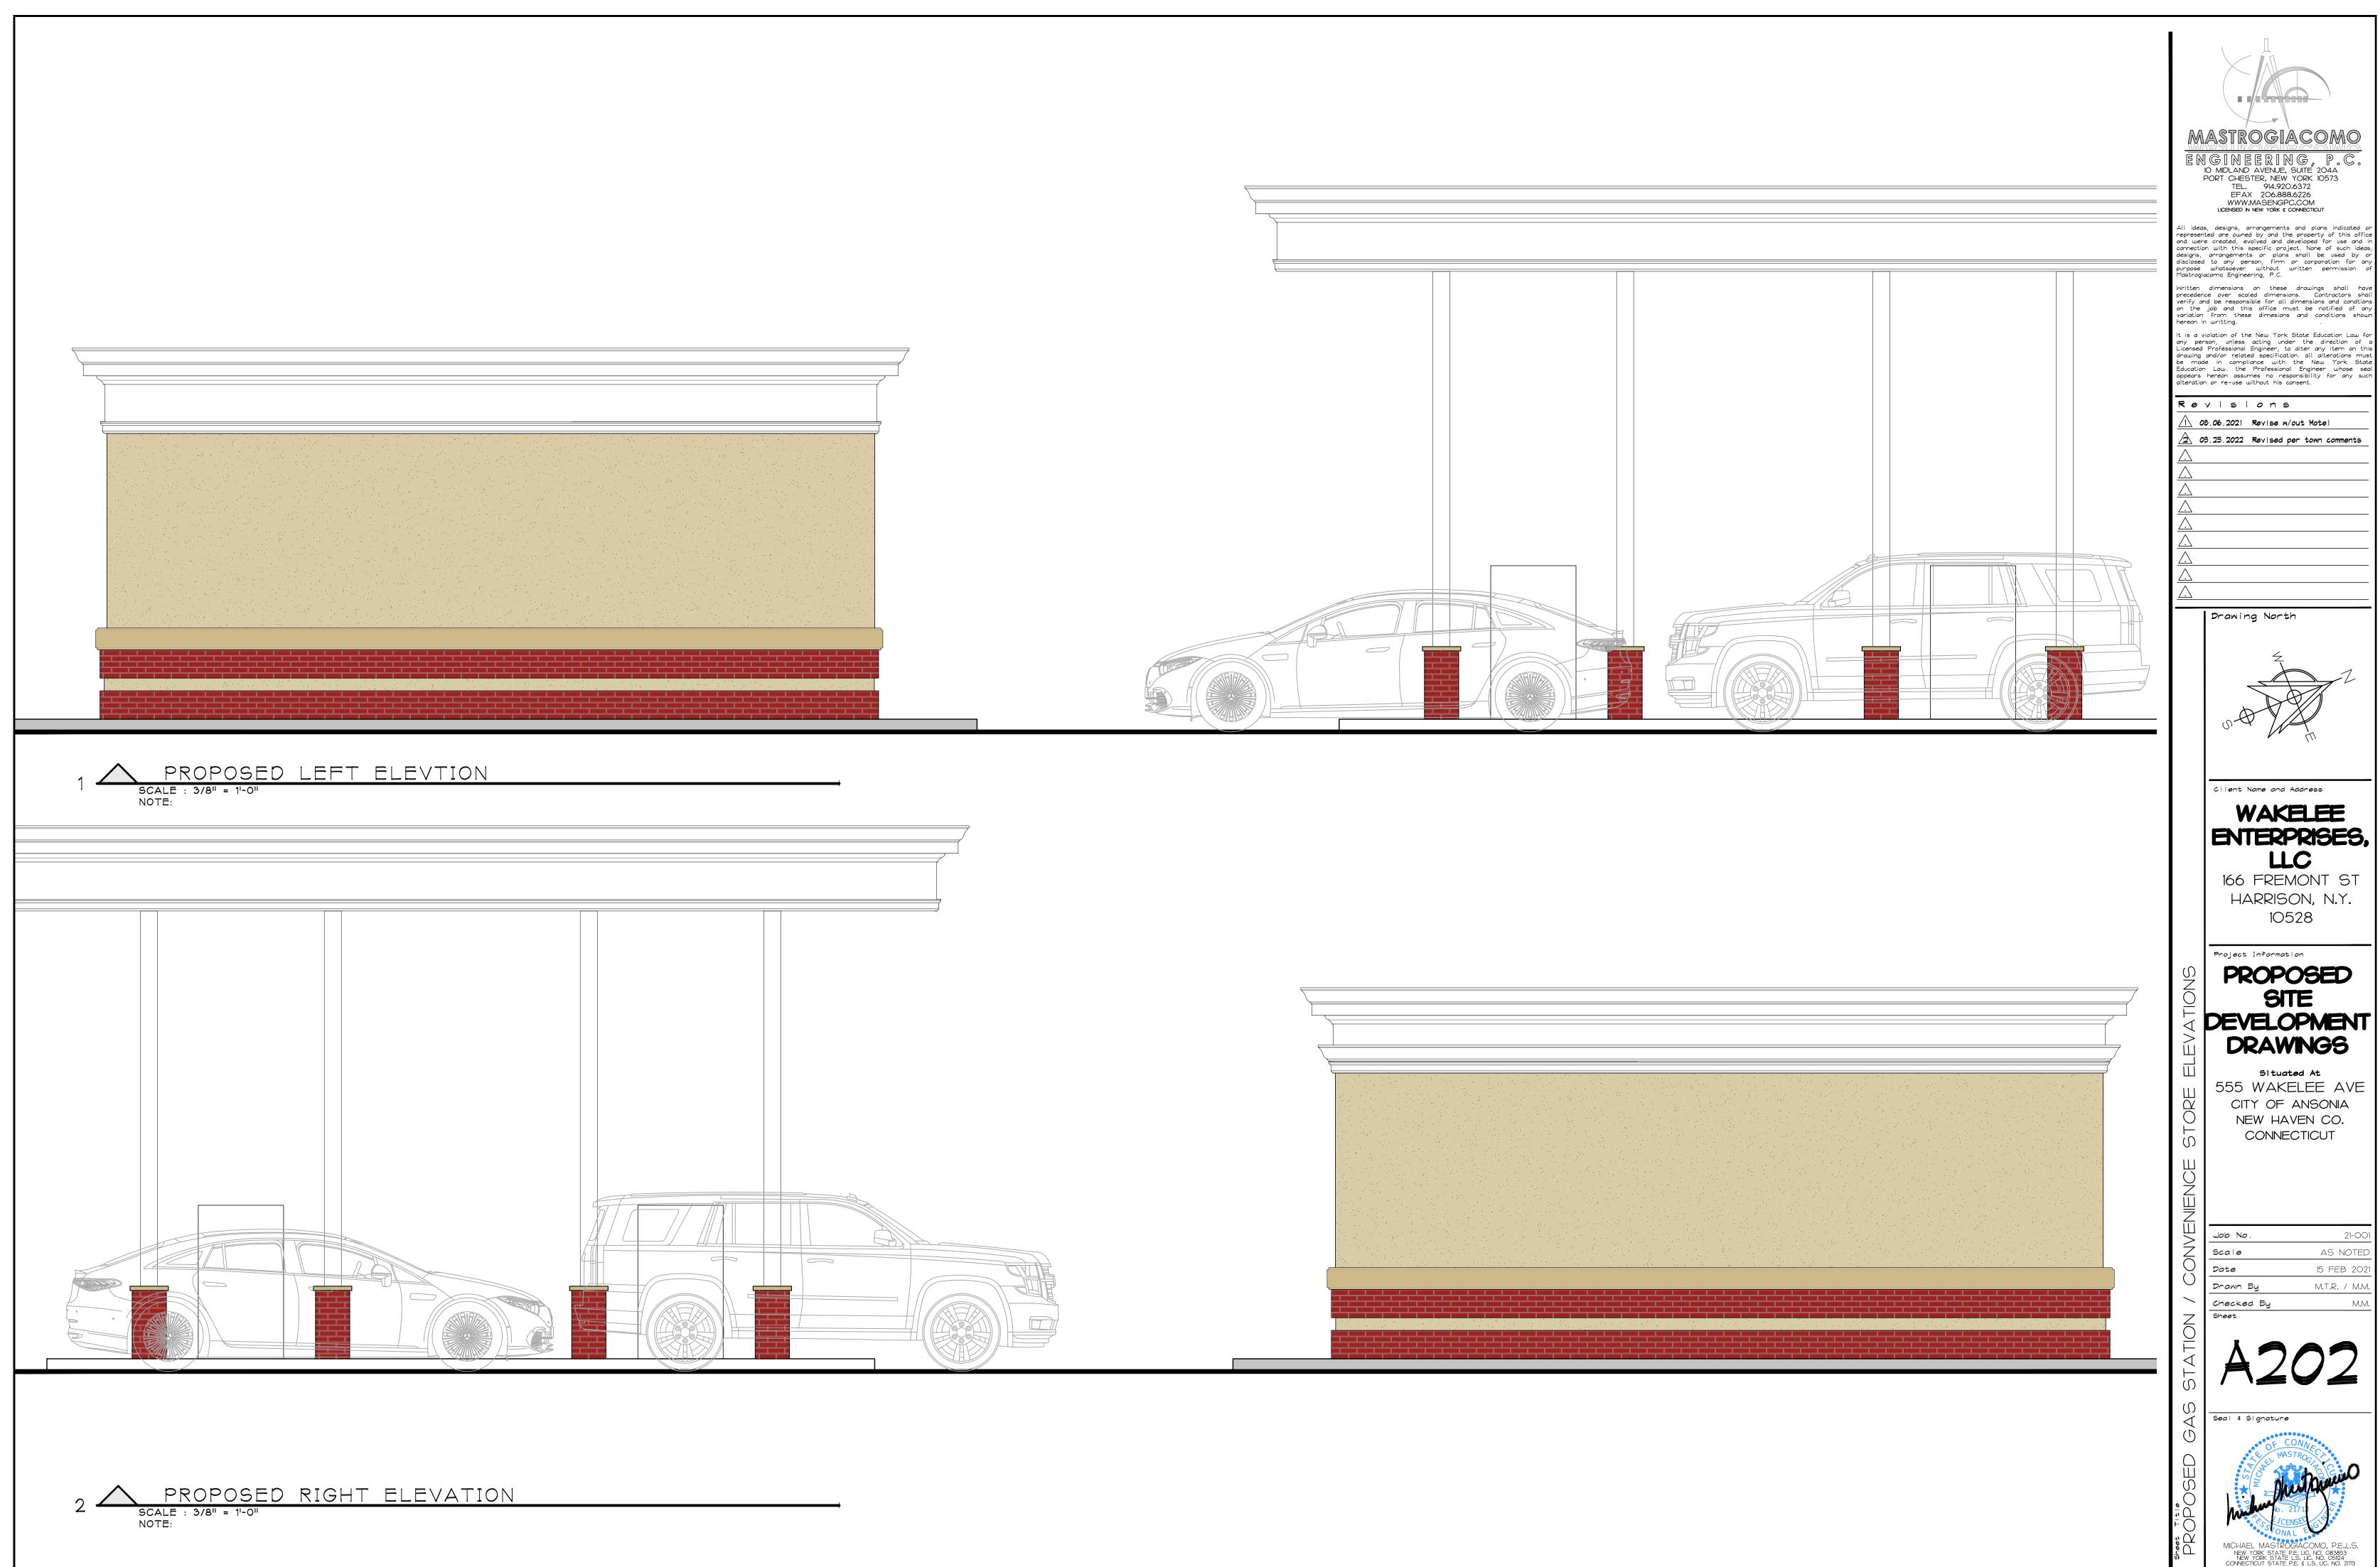


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1\ 08.06.2021 Revise m/out Motel 2 03.23.2022 Revised per town comments



ENTERPRISES,

HARRISON, N.Y.

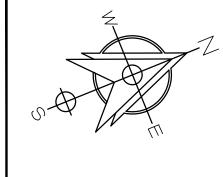PROPOSED SITE DEVELOPMENT DRAWINGS

51 tuated At 555 WAKELEE AVE CITY OF ANSONIA NEW HAVEN CO. CONNECTICUT

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$\ \ \ \ \ \ \ \ \ \ \ \ \ \ \ \ \ \ \ $	Job No.	21-001
Z	Scale	AS NOTED
Ó	Date	15 FEB 2021
)	Drawn By	M.T.R. / M.M.
\	Chacked Bu	N / N /

